

COUNTY OF SAN JOAQUIN

DEPARTMENT OF PUBLIC WORKS

P.O. BOX 1810-1810 E. HAZELTON AVENUE STOCKTON, CALIFORNIA 95201 (209) 468-3000 FAX # (209) 468-9324

Permit No: PS-1502441 Date Issued: 08/26/2016 Start Date: 08/29/2016 Exp. Date: 08/29/2017 Project No: PWP231501

Quad: NW

ENCROACHMENT PERMIT

To: UNION PACIFIC RAILROAD 9451 ATKINSON STREET ROSEVILLE, CA 95747

Encroachment Type:	•				
Roadway construction and	traffic signal			-	
widening					
		 ···			

Location:

McKinley and Industrial Intersection

In compliance with your request of <u>09/03/2015</u>, permission is hereby granted to do work in County right-of-way as shown on attached application and subject to all the terms, conditions and restrictions written below or printed as general or special provisions on any part of this form. See reverse side and attached sheet, if any.

Trench excavations for service connections will not be permitted within ten feet (10') of pavement centerline unless otherwise approved by the Director. Surface of trench patches shall match in kind and be smooth and even with that of abutting surface. Special attention shall be given to depth of utilities through roadside area in anticipation of future drainage facilities, road profile and/or frontage development. All underground utility facilities are to be established and accurately dimensioned on sketches from surveyed centerline of road right of way, or from right of way (border) lines.

Permittee shall call the Department of Public Works, Field Engineering Division (Permit Inspections) at (209)953-7421 at least forty-eight hours prior to beginning any work within the County right of way. All work performed under this permit shall conform to the rules and regulations pertaining to safety established by the California Division of Industrial Safety and Cal-OSHA.

The jobsite shall be kept in a safe condition at all times by the daily removal of any excess dirt or debris which might be a hazard to either pedestrian or automobile traffic. All necessary traffic convenience and warning devices and personnel shall be provided, placed and maintained by and at the sole expense of the Permittee in accordance with the latest edition of the CALTRANS Manual of Traffic Control.

After completion of the work permitted herein, all debris, lumber, barricades, or any excess material shall be removed and the jobsite left in a neat workmanlike manner. Immediately following completion of construction permitted herein, Permittee shall fill out and mail notice of completion (see attached post card) provided by Grantor.

Special Comments:

See attached Special Conditions. No work is permitted within 30 feet of the top of bank of North Little Johns Creek. except for work within the footprint of the existing roadway.

Traffic Control Per MUTCD and approved traffic control drawings. The exepected duration of road closure is 45 days, from approximately 8/29/16 to 10/13/16.

SS/WW,R-29 **FORMS:**

Est. Permit Fee: \$32,100.00

WHITE GOLDENROD -Permittee

-PWD Central File

YELLOW

-Field Inspection

PINK

-Permit Section

KRIS BALAJI, Director Department of Public Works

Permit Section

ENCEOVCHWEAL BERMIL GENERAL PROVISIONS

- following references: This permit is issued under and subject to all laws and ordinances of agencies-governing the encroachment herein permitted. See the
- STREETS AND HIGHWAYS CODE
- 1. Division I, Chapter 3
- 2. Division 2, Chapter 2, Section 942
- 3. Division 2, Chapter 4, Section 1126
- 4. Division 2, Chapter 5.5 and Chapter 6

ZAM 10AQUIN COUNTY ORDINANCES NUMBERED: 324, 441, 648, 662, 672, 695, 700, 860, 892, 3359, and 3675.

- Except as otherwise provided for public agencies and franchise holders, this permit is revocable on five days notice. provisions contained herein and failure on the Permittee's part to comply with any provision will be cause for revocation of this permit It is understood and sgreed by the Permittee that the performance of any work under this permit shall constitute an acceptance of all the
- shall leave the County Highway in a thoroughly neat, clean and usable condition. of the work keep the County Highway in as neat and clean condition as is possible and upon completion of the work authorized herein, All work shall be done subject to the supervision of and the satisfaction of the grantor. The Permittee shall at all times during the progress-
- by the County of San Joaquin. maintenance of the said encroachment structure, until such time as the Permittee may be relieved of the responsibility for such maintenance part of the County Highway and to immediately repair any damage to any portion of the highway, which occurs as a result of the The Permittee also agrees by the acceptance of this permit to properly maintain any encroachment structure-placed by the Permittee on any
- County Department of Public Works. The Permittee also agrees by the acceptance of this permit to make, at its own expense, such repairs as may be deemed necessary by the
- at the sole expense of the Permittee. installation provided for herein shall, upon request of the County Department of Public Works, be immediately moved or removed by and It is further agreed by the Permittee that whenever construction, reconstruction or maintenance work upon the highway is necessary, the
- way. Mo material used for fill or backfill in the construction of the encroachment shall be borrowed or taken from within the County right of
- Alagmen, as required by the particular work in progress. the protection of the traveling public. Traffic control standards shall be utilized including barricades; approved signs and lights; and within eight feet (8) of the edge of the pavement or traveled way unless otherwise provided herein. Adequate provision shall be made for All work shall be planned and carried out with as little inconvenience as possible to the traveling public. No material shall be stacked -8
- official or employee thereof, the Permittee shall defend, indemnify, and hold each of them harmless for such claim. work provided under this permit. In the event any claim of such liability is made against the County of San Joaquin or any department, which may arise out of the work herein permitted or which may arise out of the failure of the part of the Permittee to properly perform the The Permittee, by the acceptance of this permit, shall assume full responsibility for all liability for personal injury or damage to property
- commencement of operations of placing the encoachment structure. possible in its original state or shall be replaced in kind, and the roadway shall be left in at least as good a condition as it was before the work related to the permitted encroachment, such material shall either be separately stored and replaced in the roadway as nearly as by the County Department of Public Works. Wherever a gravel, crushed rock or asphalt surface is removed or damaged in the course of hereunder as may be necessary to insure the return of the roadway to a completely stable condition and until relieved of such responsibility of Public Works, such backfill shall consist of gravel or crushed rock. The Permittee shall maintain the surface over structures placed 10. All backfill material is to be moistened as necessary and thoroughly compacted with mechanical means. If required by the County Director
- by the Permittee prior to starting work. 11. Whenever it becomes necessary to secure permission from abulting property owners for the proposed work, such authority must be secured
- construction utilized. 12. The current and future safety and convenience of the traveling public shall be given every consideration in the location and methods of
- by a Licensed Land Surveyor and another Corner Record filed with the County Surveyor. (Land Surveyors' Act Section 8771) Corner Record filed with the County Surveyor. Any Survey Monuments disturbed during the course of construction shall be reestablished of construction, survey monuments that potentially may be disturbed shall be located and referenced by a Licensed Land Surveyor, and a 13. The Permittee is responsible for the preservation of survey monuments located within the area of work herein permitted. Prior to the start
- 800-227-2600 forty-eight (48) hours in advance. 14. Prior to any excavation, the Permittee shall notify USA Morth (Underground Service Alert of Morthern California and Mevada) at 811 or

PS-1502441 August 26, 2016

SPECIAL CONDITIONS FOR ENCROACHMENT PERMIT

- 1. No work outside the footprint of the existing roadway is permitted within 30 feet of the top of bank of North Little Johns Creek. Prior to beginning any work, the limit of work must be marked in the field with orange safety barrier fencing, and the location of this fencing approved by the County Inspector.
- 2. The following agencies shall be notified in writing in advance of the planned road closure:

California Highway Patrol
San Joaquin County Sheriff's Department
Stockton Police Department
Lifecom (emergency dispatch)
Stockton Fire Department
French Camp McKinley Fire District
United States Post Office

- 3. Maintain traffic controls for all roads. Traffic control delays shall not exceed 15 minutes. For roads not subject to full closure, two-way traffic shall be maintained during non-working hours, with excavated areas backfilled or plated. During working hours, two-way traffic control shall be maintained with one lane open and flaggers.
- 4. Access to all properties shall be maintained at all times except when work is occurring at the access point. Minimal delays will be allowed to provide access within the work zone area. Driveway access shall be fully restored at the end of each workday. Driveways disturbed by the contractor shall be replaced with in-kind or better materials.
- 5. Residents and businesses shall be notified in writing, as approved by the County, at least 48 hours in advance of any impacts to their access.
- 6. At least 7 calendar days prior to any road closure, Changeable Message Signs (CMS) shall be in place advising of the dates of closure. Detour signs shall be maintained throughout the closure.
- 7. All destroyed or obliterated pavement markings must be replaced in kind by the permittee. Typical pavement markings include but not limited to lane lines, centerlines, stop and stop ahead legends, limit lines, raised pavement markers and miscellaneous delineators.
- 8. Any trenches and pavement transition areas shall be maintained in a smooth and even condition to the satisfaction of the County throughout the project limits at all times.
- 9. Areas of existing asphalt not being reconstructed and subject to pavement cuts shall receive a (1)-inch asphalt concrete overlay as per San Joaquin County Improvement Standards Section 2-5.0 Trench Cut Policy.
- 10. Final paving for road resurfacing shall be per Caltrans' specifications and shall not occur between November 1 and March 31, without prior authorization from the San Joaquin County Field Engineering Division (209-953-7421).

- 11. County roads shall be kept clean from mud and debris at all times along the access points and work zone areas during entire project. All standard roadway striping and signage shall be clearly visible, maintained and restored throughout the construction zone during and after the project.
- 12. The contractor shall not conduct construction operations in rain or heavy fog conditions.

APPLICATION FOR ENCROACHMENT PERMIT

PLEASE PRINT:	
Date 6/24/15	OFFICE USE ONLY
To: San Joaquin County Department of Public Works	JOB# 231501 REF# APN N/A CR#
SIEGFRIED ENGUERENGE (Applicant Name) 3244 Brookside RO STE. 100 (Mailing Address) Sockton CA 95249 (City, State, Zip Code) 209-943-2021 (Area Code - Telephone Number)	VALID 8/25/16 TO 8/25/17 DRIVEWAYS: STREET Mckinley and Industrial * AREA Stockton QUAD NW * TYPE Road reconstruction * FORMS 55/WW R-27 NOTES Sec special conditions. Traffic control per mutch and approved drawings.
Sketch (Detailed plans may be submitted)	
Sea plans	
the Est most side of Mckinlay	nstruct and/or otherwise encroach on County Highway Right-of-Way on approximately Romer feet/mile Feet/work of Sparry, by performing the following work (description of work): acrued for the replaced with higher reflect is approximately for the replaced with higher reflect is approximately for the replaced with higher reflect is approximately for the reflect in the replaced with the reflect in the reflect is approximately for the reflect in the reflect
Work will commence on or about Fall 2015	for approximately days.
	property, or am qualified to represent the owner and agree to do the ions of San Joaquin County and subject to inspection and approval. ———————————————————————————————————
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GENERAL PROVISIONS

GOVERNING INSTALLATION OF SUBSURFACE STRUCTURES AND PIPELINES WITHIN COUNTY ROAD RIGHTS-OF-WAY

PUBLIC CONVENIENCE AND SAFETY:

- A. Before obstructing any private driveway entrance or County road traveled way with a trench, spoil bank, equipment or other barrier permitted for any prolonged period of time, the Permittee shall notify the known users of the respective thoroughfare(s) involved, and shall provide access for vehicular and pedestrian traffic to and from the road.
 - 1. Unless otherwise permitted, all work shall be conducted in such a manner that no less than one lane of the existing County road traveled way will be maintained open to public traffic during working hours in a smooth and safe riding condition(s). Two lanes shall be open after working hours.
 - In cases where road closure is permitted, the permission to close the road will be granted under the condition that the Permittee notify the
 following persons and/or agencies of the time, the period of closure, and the detour route at least twenty-four (24) hours prior to said road closure.

The County of San Joaquin Public Works Department d. The local fire district

b. The County of San Joaquin Sheriff's Office e. The local school district

c. The local postal service f. The local residents involved

- B. Should hazardous conditions relative to the installation operations warrant flagmen, as many capable flagmen as may be necessary shall be provided by the Permittee and stationed in advance of work to warn and direct traffic.
- C. Lights, signs and barricades shall be furnished, erected and maintained by the Permittee for the adequate warning and convenience of the public, with particular attention to be taken in this regard after dark.
- D. Any excess dirt and/or debris which might be a hazard to either automobile or pedestrian traffic, uncontrollable by lights, signs and barricades, shall be removed from the jobsite daily.

STRUCTURES:

- A. Walls of structures shall be such quality and strength that they will resist all pressures and will not crack or be deformed in such a way as to create a hazard or maintenance problem at any time. Therefore, the minimum structural requirements for concrete pipe placed under county road rights-of-way shall conform to the following American Association of State Highway and transportation Officials (AASHTO) designations.
 - For concrete pipe up to and including thirty-three inches (33") inside diameter, extra strength concrete conforming to AASHTO Designation M 170M.
 - 2. For concrete pipe thirty-six inches (36") inside diameter and larger, reinforced concrete pipe conforming to AASHTO Designation M 170M Class
 - . Plastic pipe conforming to AASHTO Designation M294.
- 3. All concrete pipe joints with County road rights-of-way shall be sealed against leakage and/or infiltration with rubber gasket in conformance with Section 65-1:06 of the California Standard Specifications, or with other methods as may be permitted under the Special Provisions.
- C. Cast-in-place concrete pipe, vitrified clay pipe, spiral welded steel pipe, or corrugated aluminum alloy pipe shall not be installed within the County road rights-of-way unless specifically so stated in the Special Provisions, and only under the conditions as provided.
- D. All structures to be buried within the County rights-of-way shall be set at such elevations as to allow minimum coverage of thirty inches (30") to the centerline of the roadways and twelve inches (12") at the bottoms of borrow ditches each side of the roadways. The depths of structures shall be established below a flat plane extending across the rights-of-way, no part of which shall extend above the elevations stated above; manholes, lampholes, valves, etc. not included. Future surface elevations shall be anticipated as nearly as possible and structure elevations shall be established for future adjustments accordingly.
- E. The County hereby reserves the right to specify in the Special Provisions the gage and surface treatment of any galvanized corrugated metal pipe that is to be installed.
- F. All longitudinal utility facilities are to be established (and dimensioned on sketches) from surveyed centerline of road right-of-way, not from right-of-way (border) lines.


REPAIRS OF THE COUNTY RIGHT-OF-WAY:

- All excavations shall be backfilled and compacted immediately after work therein has been completed.
- B. Trenched shall not be left open farther than 300 feet in advance of pipe laying operations, or 200 feet to the rear thereof, unless otherwise permitted by the Engineer.
- C. Unless otherwise permitted under the Special Provisions, backfill shall be placed and mechanically compacted in such a manner that the relative compaction throughout the entire fill within the County road right-of-way shall conform to the percentages of compaction as shown on the Trench detail.
- D. Backfill material shall be placed in horizontal uniform layers not to exceed in thickness, before compaction, 0.67 foot in the bedding region, one –foot where 90% compaction is required, and two-feet where 80% compaction is required.
- E. No portion of the excavation(s) shall be compacted by ponding or jetting unless a maintenance bond is provided.
- F. Gravel backfill material shall be utilized only where specifically so stated on the face of the permit. It shall be compacted by means of a high-frequency internal vibrator, the compactor to be a size and type approved by the Engineer. Points of compaction shall not be greater than 18" centers and to the full depth of the lift.
- G. All pavements, curbs, gutters, sidewalks, borrow ditches, pipes, head walls, road signs, trees, shrubbery, and/or other permanent road facilities impaired by or as a result of construction operations at the construction site(s) occupied by materials and/or equipment, shall be restored immediately upon backfilling of the excavation to the original grades and cross sections, and to a condition as good as, or better than existing prior to construction.
- H. All surfacing materials of roadways and driveway approaches cut or damaged by or as a result of construction operations, shall be replaced within ONE WEEK following the backfilling of excavation, weather permitting, with compacted layers of surfacing materials at least as thick as the existing, and no less than two inches (2") of asphalt concrete over six inches (6") of aggregate base, both as specified below.
 - 1. Asphalt Concrete: Combined mineral aggregate shall conform to the quality and gradation requirements for Type "B" one-half inch(1/2) maximum aggregate, coarse or medium gradation as specified in Section 39 of the California Standard Specifications. The bituminous binder to be mixed with mineral aggregate shall be paving asphalt having (Grade PG 64-10), unless otherwise directed by the Engineer. Placement of asphalt concrete surfacing shall conform to the applicable provisions of Section 39 of the California Standard Specifications.
 - 2. Aggregate Base: Combined mineral aggregates shall conform to the quality and the grading for three-quarter inch (3/4") maximum size aggregate Class 2 Aggregate Base specified in Section 26 of the California Standard Specifications.
- I. Before acceptance of repairs to the County road rights-of-way, all unsightly and detrimental dirt, dust and/or debris shall be removed and the construction areas left in a neat and presentable condition(s).
 - 1. If necessary, County road traveled way and driveway pavements shall be washed with water to remove dirt and dust.
 - 2. Driveway approaches and field entrance pavements damaged by equipment or spoil banks shall be repaired as directed by the Engineer.
- J. Upon request by the County, any settlement, sagging of surface, or cracking of pavement shall be repaired immediately by and at the sole expense of the Permittee for a period of one year following acceptance of the work.

SPECIAL PROVISIONS


Winter Weather Utility Work

- 1. <u>SUPERVISION:</u> The utility company (**permittee**) shall furnish full-time supervision of all work to insure compliance with the permit provision.
- 2. <u>START OF WORK:</u> No work within the County right-of-way shall be started until the utility company representative has made an evaluation of weather conditions and has determined the work can be accomplished under the provisions of the permit.
- 3. <u>CLEAN PAVEMENT:</u> Dirt and mud shall not be deposited on the pavement outside the area of work, and if inadvertently tracked onto the road travel way shall be removed immediately.
- **4. DAILY RESTORATION:** Private driveways and road intersections shall be restored daily.
- 5. WEATHER-TIGHT CONDITIONS: All trenches shall be filled and compacted, ditches and other drainage facilities regarded and opened, and the entire work area restored to weather-tight condition prior to any rain.

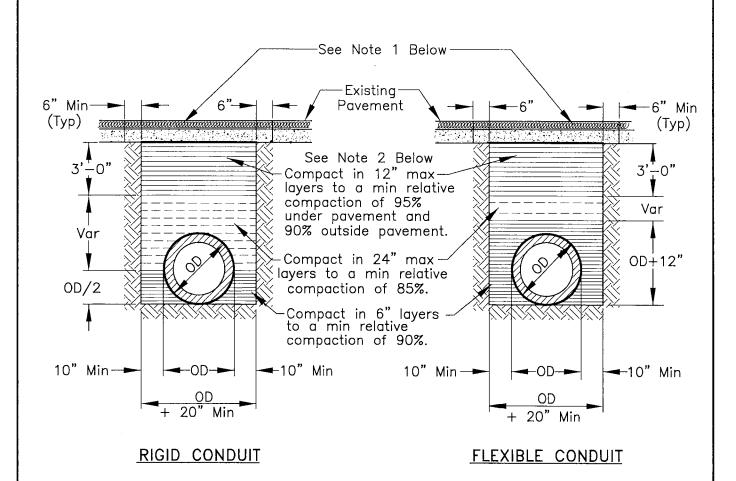

NOTES:

- 1. New pavement shall be 1" thicker than existing pavement, minimum of 0.25 Ft. New base shall be 1" thicker than existing base, min of 0.50 Ft.
- 2. Select native material or imported granular material as approved by the Director of Public Works. Backfill with materials equal to or better than the existing pavement and base in quality.
- 3. Relative compaction of materials shall be tested in accordance with the State of California, Dept. of Transportation Testing Manuals, test method No. California 216 or 231.
- 4. All existing pavement shall be neatly cut to line prior to trench excavation.
- 5. Jetting or ponding will be permitted within the street right—of—way with a 3 year bond, when approved by the Director of Public Works.
- 6. When shown by soil composition and compactability, ninety percent (90%) compaction may be used, when approved by the Director of Public Works.
- 7. Special bedding and backfill requirements may be shown on the plans or specified in the special provisions.

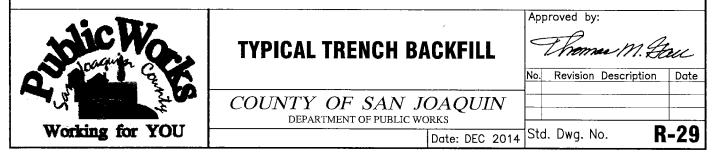

STOCKTON, CALIFORNIA **OAKLAND SUBDIVISION MP 90.37** INDUSTRIAL DRIVE/McKINLEY AVENUE AND UPRR CROSSING SAFETY IMPROVEMENTS

WORK ORDER: PROJECT NUMBER: BUDGET REFERENCE:


27536 89401 14EN10

PROJECT INDEX

CIVIL	DESCRIPTION
G001	TITLE SHEET
G002	GENERAL NOTES AND SPECIFICATIONS
G003	LEGEND & ABBREVIATIONS
V001	TOPOGRAPHIC AND DEMOLITION PLAN McKINLEY AVE. STA 28+50 TO 34+50
V002	TOPOGRAPHIC AND DEMOLITION PLAN McKINLEY AVE. STA 34+50 TO 40+50
V003	TOPOGRAPHIC AND DEMOLITION PLAN INDUSTRIAL DR. STA 1+00 TO 5+50
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R004	TYPICAL CROSS SECTIONS AND DETAILS
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X002	SECTIONS II

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TRAFFIC SIGNAL	DESCRIPTION
GN-1	TRAFFIC SIGNAL NOTES
TS-1	TRAFFIC SIGNAL PLAN 1
TS-2	TRAFFIC SIGNAL PLAN 2
TS-3	TRAFFIC SIGNAL SCHEDULE
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RAFFIC CONTROL	DESCRIPTION								
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TC002	TRAFFIC	CONTROL	PLAN I						
TC003	TRAFFIC	CONTROL	PLAN II						

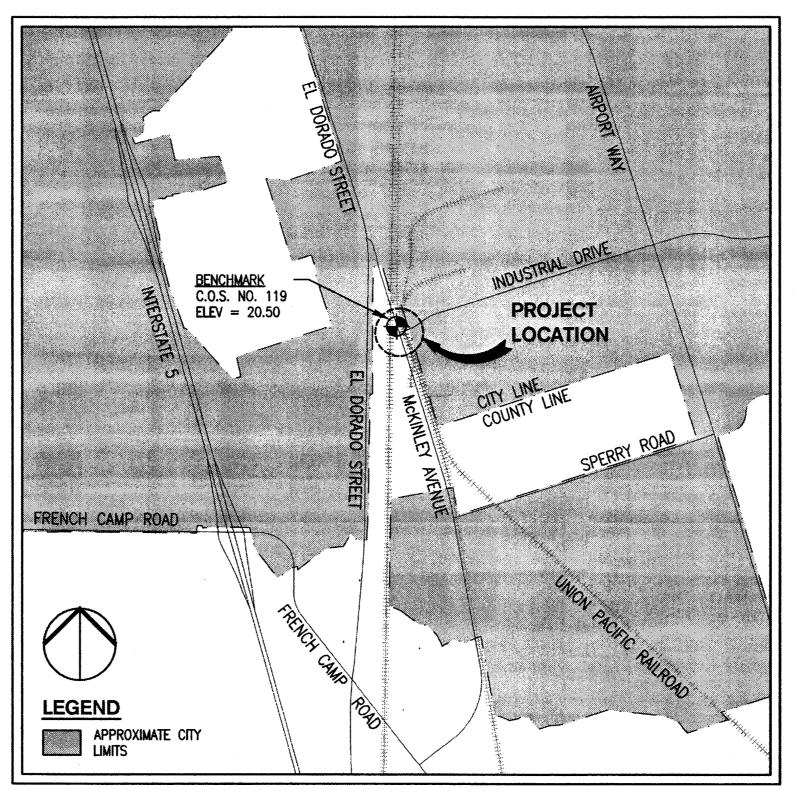

VICINITY MAP NOT TO SCALE

PROJECT CONTACTS:

TROJECT CONT	71070 .
UNION PACIFIC RAILROAD	
CONTACT	PHONE NUMB
JAMES MROSS	402.250.5375
TYSON PAYNE	801.520.3176
KEVIN P. NORDEN	909.685.2137
COOPER MINTO	402.544.2046
DAVID NIELSEN	402.540.3330
MICHAEL A. SMITH	402.544.3438
DAMIAN G. WALLNER	402.544.2452
PEGGY YGBUHAY	916.789.5033
MICHAEL HEALD	402.544.3719
MICHAEL BARRERA	402.544.4365
DANIELLE P. ALLEN	402.544.8020
UPRR CALL BEFORE YOU DIG	800.336.9193
CALL BEFORE YOU DIG	888.258.0808
(NATIONAL DIRECTORY)	
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888.877.7267 UPRR RESPONSE MANAGEMENT COMMUNICATIONS CENTER

UPRR SIGNAL OPERATIONS

800.877.5591

SIEGFRIED ENGINEERING, INC. 3244 BROOKSIDE ROAD, SUITE 100 STOCKTON, CA 95219 PAUL J. SCHNEIDER, P.E. CONTACT: (209) 943-2021 pjs@siegfriedeng.com

SIGNING AND STRIPING, AND TRAFFIC SIGNAL STANTEC CONSULTING INC. 1340 TREAT BOULEVARD, SUITE 300 WALNUT CREEK, CA 94597 CONTACT: JOY BHATTACHARYA, P.E. (925) 941-1400 joy.bhattacharya@stantec.com

STATEWIDE TRAFFIC SAFETY & SIGNS 7920 CUCAMONGA AVE. SACRAMENTO, CA 95826 CONTACT: JOE MURPHY (916) 452-4855 jmurphy@STSSI.com

CIVIL CONSTRUCTION PROJECT MANAGER

MANAGER OF SPECIAL PROJECTS INDUSTRY & PUBLIC PROJECTS

CIVIL CONSTRUCTION FIELD MANAGER TRACK CONSTRUCTION PROJECT MANAGER

SENIOR PROJECT DESIGN MANAGER

INFORMATION TECHNOLOGY - FIBER

PROJECT DESIGN MANAGER SIGNAL DESIGN MANAGER STRUCTURES DESIGN MANAGER

REAL ESTATE - UTILITIES REAL ESTATE - ACQUISITIONS

SAN JOAQUIN COUNTY: SAN JOAQUIN COUNTY PUBLIC WORKS 1810 E. HAZELTON AVENUE STOCKTON, CA 95201 CONTACT: JAYNA RUTZ (209) 468-3056 jrutz@sjgov.com

CITY OF STOCKTON: CITY OF STOCKTON - PUBLIC WORKS 345 NORTH EL DORADO STREET STOCKTON, CA 95202 CONTACT: CLIFTON GAYOTIN (209) 937-8241

cliff.gayotin@stocktongov.com

DEPATERMENT OF PUBLIC WORKS APPROVED AS "ENCROACHMENT PERMIT PLAN SET"

COUNTY OF SAN JOAQUIN

CITY ENGINEER
STOCKTON, CALIFORNIA ENCROACHMENT PERMIT NO.: PS-150244 DATE ISSUED:


UNION PACIFIC

Office of Assistant Vice President **Engineering Design/Construction**

Stockton, California Oakland Subdivision MP 90.37

SIEGFRIED



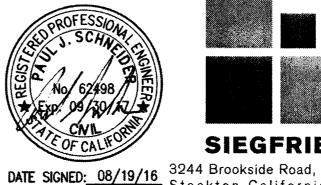

DATE SIGNED: 08/19/16 3244 Brookside Road, Suite 100 Stockton, California 95219

SHEET NUMBER G001

RAILROAD CHECKED BY: PJS LOCATION & DESCRIPTION: 08/19/2016

Industrial Drive/McKinley Avenue and UPRR Crossing Safety Improvements

TITLE SHEET

BENCHMARK: CITY OF STOCKTON BENCHMARK NO. 119

BRASS DISK MARKING C.O.S. MONUMENT STAMPED "3S-2" IN MONUMENT WELL ON THE WEST SIDE OF MCKINLEY AVENUE AT THE APPROXIMATE CENTERLINE OF INDUSTRIAL DRIVE, EAST OF THE WESTERN PACIFIC R.R. R/W, EXTENDED WESTERLY.

ELEVATION = 20.50

DATUM = NAVD 88 (2008 REVISION, CITY OF STOCKTON)

GENERAL NOTES

- 1. ELEVATIONS ARE REFERRED TO NAVD 88 (2008 REVISION, CITY OF STOCKTON).
- 2. THE CITY OF STOCKTON STANDARD PLANS AND DETAILS AS SHOWN HEREON ARE FOR THE CONVENIENCE OF THE CONTRACTOR. PRIOR TO AND DURING CONSTRUCTION, THE CONTRACTOR SHALL BE RESPONSIBLE FOR BEING FAMILIAR WITH THE CURRENT CITY OF STOCKTON STANDARDS AND ALL UPDATES AND REVISIONS MADE TO ANY OF THE CITY OF STOCKTON STANDARD DETAILS SHOWN ON THESE PLANS. THE CONTRACTOR IS ALSO RESPONSIBLE FOR BEING FAMILIAR WITH THE WRITTEN SPECIFICATIONS AND/OR OTHER STANDARD DETAILS NOT SHOWN BUT WHICH ARE INCLUDED IN THE CITY OF STOCKTON STANDARD SPECIFICATIONS AND PLANS.
- 3. ALL IMPROVEMENTS SHALL BE CONSTRUCTED IN STRICT ACCORDANCE WITH THE FOLLOWING: CITY OF STOCKTON STANDARD SPECIFICATIONS AND PLANS ADOPTED NOVEMBER 25, 2003, AND ALL AMENDMENTS THERETO TO DATE, AND/OR CALIFORNIA DEPARTMENT OF TRANSPORTATION STANDARD SPECIFICATIONS (CALTRANS) LATEST EDITION, WHERE APPLICABLE. WHERE THERE IS A CONFLICT BETWEEN THE PLANS AND THE CITY'S STANDARD SPECIFICATIONS AND PLANS. THE CITY OF STOCKTON STANDARD SPECIFICATIONS AND PLANS SHALL PREVAIL. ALL WORK SHALL BE UNDER THE INSPECTION OF THE CITY OF STOCKTON AND SAN JOAQUIN COUNTY AND/OR UPRR.
- 4. DRAWING NUMBERS SHOWN ON THE PLANS REFER TO COUNTY OF SAN JOAQUIN STANDARD PLANS, SHOWN THUS: DWG. NO. R28A & R28B UNLESS OTHERWISE NOTED.
- 5. THE CONTRACTOR SHALL BE RESPONSIBLE FOR PROTECTING FROM DAMAGE ALL EXISTING IMPROVEMENTS THAT ARE TO REMAIN. SUCH IMPROVEMENTS THAT ARE DAMAGED BY THE CONTRACTOR SHALL BE REPLACED AT HIS EXPENSE.
- 6. EXCAVATION OF 5 FEET OR MORE IN DEPTH WILL REQUIRE AN EXCAVATION PERMIT FROM THE STATE OF CALIFORNIA DEPARTMENT OF INDUSTRIAL SAFETY.
- 7. THE CONTRACTOR SHALL DEMOLISH, EXCAVATE, REMOVE AND DISPOSE OF ALL EXISTING CONCRETE CURB, GUTTER OR SIDEWALK, ASPHALT CONCRETE PAVING, AND DELETERIOUS MATERIAL AS REQUIRED TO CONSTRUCT THE CONTRACT WORK. ALL SUCH EXCESS MATERIAL GENERATED SHALL BE DISPOSED OF FROM THE SITE BY THE CONTRACTOR.
- 8. WORK IN PUBLIC RIGHT-OF-WAY IS SUBJECT TO THE APPROVAL AND ACCEPTANCE OF THE CITY OF STOCKTON PUBLIC WORKS DEPARTMENT AND SAN JOAQUIN COUNTY PUBLIC WORKS.
- 9. EXISTING UTILITIES ARE SHOWN AS THEY ARE BELIEVED TO EXIST. THE OWNER AND THE ENGINEER DO NOT ACCEPT RESPONSIBILITY FOR THEIR ACCURACY. PRIOR TO COMMENCING ANY WORK, THE CONTRACTOR SHALL HAVE EACH UTILITY COMPANY ACCURATELY LOCATE IN THE FIELD THEIR MAINS AND SERVICE LINES. IT SHALL BE THE CONTRACTOR'S RESPONSIBILITY TO PROTECT ALL EXISTING utilities.
- 10. ATTENTION IS CALLED TO: SECTION 1540 (A) (1) OF THE CONSTRUCTION SAFETY ORDERS (TITLE 8 CALIFORNIA ADMINISTRATION CODE SECTION 1540), ISSUED BY THE OCCUPATIONAL SAFETY AND HEALTH STANDARDS BOARD PURSUANT TO THE CALIFORNIA OCCUPATIONAL SAFETY AND HEALTH ACT OF 1973, AS AMENDED, WHICH STATES:
 - "PRIOR TO OPENING AN EXCAVATION, EFFORT SHALL BE MADE TO DETERMINE WHETHER UNDERGROUND INSTALLATION I.E., SEWER, WATER, FUEL, ELECTRIC LINES, ETC., WILL BE ENCOUNTERED AND, IF SO, WHERE SUCH UNDERGROUND INSTALLATIONS ARE LOCATED. WHEN THE EXCAVATION APPROACHES THE APPROXIMATE LOCATION OF SUCH AN INSTALLATION, THE EXACT LOCATION SHALL BE DETERMINED BY CAREFUL PROBING OR HAND DIGGING AND WHEN IT IS UNCOVERED, ADEQUATE PROTECTION SHALL BE PROVIDED FOR THE EXISTING INSTALLATION. ALL KNOWN OWNERS OF UNDERGROUND FACILITIES IN THE AREA CONCERNED SHALL BE ADVISED OF PROPOSED WORK AT LEAST 48 HOURS PRIOR TO THE START OF ACTUAL EXCAVATION."
- 11. THE CONTRACTOR SHALL ATTEND A PRE—CONSTRUCTION CONFERENCE WITH UNION PACIFIC RAILROAD, THE CITY OF STOCKTON, AND SAN JOAQUIN COUNTY PRIOR TO STARTING ANY WORK.
- 12. CONTRACTOR SHALL CONTACT JASON ENDER (209) 937-8381 OF THE CITY OF STOCKTON FOR A PRE-CONSTRUCTION CONFERENCE A MINIMUM OF THREE (3) WORKING DAYS PRIOR TO THE COMMENCEMENT OF WORK.
- 13. PRIOR TO COMMENCING ANY WORK, IT SHALL BE THE CONTRACTOR'S RESPONSIBILITY TO HAVE EACH UTILITY COMPANY LOCATE IN THE FIELD THEIR MAIN SERVICE LINES. THE CONTRACTOR SHALL NOTIFY MEMBERS OF THE UNDERGROUND SERVICE ALERT (U.S.A.) 48 HOURS IN ADVANCE OF PERFORMING EXCAVATION WORK BY CALLING THE TOLL-FREE NUMBER (800-227-2600).
- 14. THE CONTRACTOR SHALL CHECK WITH THE UTILITY COMPANIES AND VERIFY ALL UTILITY LOCATIONS. IT SHALL BE CONTRACTOR'S SOLE RESPONSIBILITY TO PROTECT ALL EXISTING UTILITIES SO THAT NO DAMAGE RESULTS TO THEM DURING THE PERFORMANCE OF HIS CONTRACT. THE CONTRACTOR SHALL BE REQUIRED TO COOPERATE WITH OTHER CONTRACTORS AND UTILITY COMPANIES INSTALLING NEW STRUCTURES, UTILITIES AND SERVICES TO THE DEVELOPMENT.
- 15. WHENEVER EXISTING PAVEMENT IS BROKEN OR CUT DURING THE INSTALLATION OF THE WORK COVERED BY THESE PLANS AND SPECIFICATIONS. THE PAVEMENT SHALL BE REPLACED WITH PAVEMENT MATERIALS EQUAL TO OR BETTER THAN THE MATERIALS USED IN THE ORIGINAL PAVING. THE FINISHED PAVEMENT SHALL BE SUBJECT TO THE APPROVAL OF THE CITY ENGINEER IF LOCATED WITHIN CITY RIGHT-OF-WAY.
- 16. PAYMENT FOR PAVEMENT WILL BE MADE FOR THE AREAS SHOWN ON THE PLANS, REPLACEMENT OF PAVEMENT WHICH IS BROKEN OR CUT IN THE INSTALLATION OF THE IMPROVEMENTS COVERED BY THESE PLANS AND SPECIFICATIONS, AND WHICH LIES OUTSIDE OF SAID AREAS, SHALL BE INCLUDED IN THE STREET CONTRACTOR'S UNIT PRICE FOR PAVEMENT, AND NO ADDITIONAL PAYMENT SHALL BE MADE FOR SUCH WORK.
- 17. THE CONTRACTOR SHALL EXPOSE EXISTING STORM DRAINS AND SANITARY SEWERS WHERE CONNECTIONS ARE TO BE MADE SO EXISTING FLOWLINES AND LOCATIONS CAN BE VERIFIED BEFORE THE START OF CONSTRUCTION.
- 18. THE CONTRACTOR AGREES THAT HE SHALL ASSUME SOLE AND COMPLETE RESPONSIBILITY FOR JOBSITE CONDITIONS DURING THE COURSE OF CONSTRUCTION OF THIS PROJECT INCLUDING SAFETY OF ALL PERSONS AND PROPERTY, THAT THIS REQUIREMENT SHALL APPLY CONTINUOUSLY AND NOT BE LIMITED TO NORMAL WORKING HOURS, AND THAT THE CONTRACTOR SHALL DEFEND, INDEMNIFY AND HOLD THE OWNER, UPRR, AND THE ENGINEER HARMLESS FROM ANY AND ALL LIABILITY. REAL OR ALLEGED, IN CONNECTION WITH THE PERFORMANCE OF WORK ON THIS PROJECT. EXCEPTING FOR LIABILITY ARISING FROM THE SOLE NEGLIGENCE OF THE OWNER OR THE ENGINEER.
- 19. CONSTRUCTION STAKING:
- IF SIEGFRIED ENGINEERING IS NOT PERFORMING THE CONSTRUCTION STAKING, AND AN ERROR OR OMISSION ON THE PLANS IS DISCOVERED BY THE SURVEYOR PERFORMING THE CONSTRUCTION STAKING DURING THE PREPARATION OF THE STAKING PLAN AND IT IS NOT IMMEDIATELY BROUGHT TO THE ATTENTION OF SIEGFRIED ENGINEERING THEN SIEGFRIED ENGINEERING CANNOT, AND WILL NOT TAKE RESPONSIBILITY FOR THE CONSTRUCTION COSTS HAD THE ERROR OR OMISSION BEEN MITIGABLE PRIOR TO CONSTRUCTION.
- 20. THE CONTRACTOR SHALL OBTAIN A PERMIT FROM THE CALIFORNIA WATER SERVICE COMPANY FOR USE OF WATER FROM FIRE HYDRANTS FOR CONSTRUCTION PURPOSES. THE PERMIT SHALL BE APPROVED BY THE CITY OF STOCKTON FIRE DEPARTMENT.

- 21. THE PROPERTY OWNERS, DEVELOPERS, AND/OR SUCCESSORS IN INTEREST SHALL COMPLY WITH THE PROVISIONS OF THE CALIFORNIA GENERAL CONSTRUCTION ACTIVITY STORM WATER PERMIT AND STATE WATER RESOURCES CONTROL BOARD ORDER NUMBER 2010-0014-DWQ. COMPLIANCE IS MANDATORY PER CHAPTER 15, SECTIONS 15.48.010 THROUGH 15.48.140 OF THE STOCKTON MUNICIPAL CODE.
- 22. THE CONTRACTOR SHALL BE RESPONSIBLE FOR ALL PERMITS AND LICENSES REQUIRED FOR THE CONSTRUCTION AND COMPLETION OF THE PROJECT. THE CONTRACTOR SHALL OBTAIN AN ENCROACHMENT PERMIT AND A GRADING AND EROSION CONTROL PERMIT (FROM BOTH SAN JOAQUIN COUNTY AND CITY OF STOCKTON) PRIOR TO SCHEDULING A PRE-CONSTRUCTION MEETING OR STARTING ANY WORK, UNLESS OTHERWISE APPROVED BY THE CITY AND COUNTY.
- 23. CONTRACTOR SHALL OBTAIN AN ENCROACHMENT PERMIT WHERE APPLICABLE FOR ANY WORK DONE WITHIN THE RIGHTS-OF-WAY OR EASEMENTS FROM CITY OF STOCKTON, AND SAN JOAQUIN COUNTY. CONTRACTOR SHALL NOTIFY CITY, 24 HOURS IN ADVANCE OF COMMENCING THE WORK OR AS REQUIRED BY SAID PERMITS.
- 24. ALL STATIONS REFER TO DISTANCES ALONG STREET CENTERLINE, UNLESS OTHERWISE NOTED. ALL STATIONS OFF CENTERLINE ARE PERPENDICULAR TO OR RADIALLY OPPOSITE CENTERLINE STATIONS.
- 25. ACTUAL CONNECTIONS TO EXISTING WATER LINES WILL NOT BE PERMITTED PRIOR TO THE COMPLETION OF STERILIZATION AND TESTING OF NEW WATER MAINS. ALL WATER VALVES TO BE OPERATED UNDER THE DIRECTION OF THE WATER DIVISION OF THE REGULATORY AGENCY
- 26. CONTRACTOR SHALL INSTALL A BLUE REFLECTOR 6-INCHES FROM THE CENTERLINE ON FIRE HYDRANT SIDE AT ALL FIRE HYDRANT LOCATIONS PER MUTCD, CALIFORNIA SUPPLEMENT, SECTION 3B.11 AND FIGURE 3B-102. CONTRACTOR SHALL PAINT FIRE HYDRANTS WITH ENAMEL SAFETY YELLOW PAINT. FIRE HYDRANT STEM BREAKAWAY MUST COINCIDE WITH BREAKAWAY SPOOL.
- 27. ANY FIRE HYDRANTS TO BE REMOVED NEEDS TO BE RETURNED TO THE FIRE DEPARTMENT. CONTACT BILL CATLETT AT (209) 937-7420.
- 28. DUST CONTROL SHALL BE PERFORMED AT ALL TIMES, AT THE CONTRACTORS' EXPENSE, TO MINIMIZE ANY DUST NUISANCE AND SHALL BE IN ACCORDANCE WITH SECTION 10 OF CALTRANS STANDARD SPECIFICATIONS AND THE REQUIREMENTS OF THE CITY OF STOCKTON.
- 29. THE CONTRACTOR SHALL FURNISH, INSTALL OPERATE AND MAINTAIN ALL MACHINERY, APPLIANCES AND EQUIPMENT TO MAINTAIN ALL EXCAVATIONS FREE FROM WATER DURING CONSTRUCTION, AND SHALL DEWATER AND DISPOSE OF THE WATER SO AS TO NOT CAUSE INJURY TO PUBLIC OR PRIVATE PROPERTY, OR TO CAUSE A NUISANCE OR MENACE TO THE PUBLIC. THE DEWATERING SYSTEM SHALL BE INSTALLED AND OPERATED SO THE GROUNDWATER LEVEL OUTSIDE THE EXCAVATION IS NOT REDUCED TO THE EXTENT WHICH WOULD CAUSE DAMAGE OR ENDANGER ADJACENT STRUCTURES OR PROPERTY. ALL COSTS FOR DEWATERING SHALL BE INCLUDED IN THE UNIT PRICE BID FOR ALL PIPE CONSTRUCTION. THE STATIC WATER LEVEL SHALL BE DRAWN DOWN A MINIMUM OF 1 FOOT BELOW THE BOTTOM OF EXCAVATION OF ANY FILL TO THE SPECIFIED DENSITY. DISPOSAL OF WATER SHALL BE IN ACCORDANCE WITH THE APPROVED SWPPP AND SHALL NOT DAMAGE PROPERTY, CREATE A PUBLIC NUISANCE OR VIOLATE THE LAW. THE CONTRACTOR SHALL HAVE ON HAND. PUMPING EQUIPMENT AND MACHINERY IN GOOD WORKING CONDITION FOR EMERGENCIES AND SHALL HAVE WORKMEN AVAILABLE FOR ITS OPERATION. THE DEWATERING SYSTEM SHALL OPERATE CONTINUOUSLY UNTIL BACK-FILL HAS BEEN COMPLETED TO 1 FOOT ABOVE THE NORMAL STATIC GROUNDWATER LEVEL.
- 30. UTILIZE A SEDIMENTATION OR FILTERING CONTROL MEASURE TO REMOVE SEDIMENT FROM DEWATERING WATERS PRIOR TO DISCHARGE. SEE SEDIMENT FILTER DETAIL ON THE EROSION CONTROL PLAN.
- 31. IN ACCORDANCE WITH THE REQUIREMENTS OF THE RECENTLY ADOPTED STORM WATER NPDES PERMIT. THE FOLLOWING MUST BE SUBMITTED PRIOR TO OR DURING THE PRECONSTRUCTION MEETING:
 - A. TRANSMITTAL MEMO THAT INCLUDES: * THE NAME AND PHONE NUMBER OF THE PERSON RESPONSIBLE FOR SWPPP IMPLEMENTATION, AND
 - B. COPY OF A SIGNED NOTICE OF INTENT FORM OR A WASTE DISCHARGE IDENTIFICATION NUMBER.
- 32. THE DISCHARGE OF CHLORINATED AND DE-CHLORINATED WATER INTO THE STORM DRAIN SYSTEM IS PROHIBITED. THE DISCHARGE OF CHLORINATED AND DE-CHLORINATED WATER INTO THE SANITARY SEWER SYSTEM REQUIRES PRIOR APPROVAL FROM MUD. CONTACT RICHARD STIFFLER AT
- 33. LOCATION OF SAW CUTTING AS REPRESENTED ON THESE PLANS SHALL BE DETERMINED IN THE FIELD WITH THE PUBLIC WORKS AND UPRR INSPECTORS. IF THE EXISTING SECTION REQUIRES GRINDING OR OVERLAYING OF AC, IT SHALL BE DETERMINED IN THE FIELD WITH THE PUBLIC WORKS AND UPRR INSPECTORS.
- 34. THE CONTRACTOR SHALL PROVIDE ALL LIGHTS, BARRICADES, SIGNS, FLAGMEN OR OTHER DEVICES NECESSARY FOR PUBLIC SAFETY.
- 35. CONTRACTOR SHALL ADHERE TO THE SUBMITTED AND APPROVED TRAFFIC CONTROL AND/OR DETOUR PLAN INCLUDED IN THESE PLANS DURING CONSTRUCTION.
- 36. ALL FIELD CHANGES SHALL BE APPROVED BY THE COUNTY AND CITY ENGINEER, AND UPRR.
- 37. WHENEVER EXISTING FACILITIES ARE REMOVED, DAMAGED, BROKEN OR CUT IN THE INSTALLATION OF THE WORK COVERED BY THESE PLANS OR SPECIFICATIONS, SAID FACILITIES SHALL BE REPLACED AT THE CONTRACTOR'S EXPENSE, AFTER PROPER BACKFILLING AND/OR CONSTRUCTION. WITH MATERIALS EQUAL TO OR BETTER THAN THE MATERIALS USED IN THE ORIGINAL EXISTING FACILITIES. THE FINISHED PRODUCT SHALL BE SUBJECT TO THE APPROVAL OF THE OWNER, THE ENGINEER, AND THE RESPECTIVE REGULATORY AGENCY.
- 38. THE CONTRACTOR SHALL MAINTAIN A NEATLY MARKED SET OF FULL-SIZE AS-BUILT RECORD DRAWINGS SHOWING THE FINAL LOCATION AND LAYOUT OF ALL MECHANICAL; ELECTRICAL AND OTHER INSTRUMENTATION EQUIPMENT; PIPING AND CONDUITS, STRUCTURES AND OTHER FACILITIES. THE AS-BUILTS OF THE ELECTRICAL SYSTEM SHALL INCLUDE THE STREET LIGHT LAYOUT PLAN SHOWING LOCATION OF LIGHTS, CONDUITS, CONDUCTORS, POINTS OF CONNECTIONS TO SERVICES. PULLBOXES, AND WIRE SIZES. AS-BUILT RECORD DRAWINGS SHALL REFLECT CHANGE ORDERS. ACCOMMODATIONS, AND ADJUSTMENTS TO ALL IMPROVEMENTS CONSTRUCTED. WHERE NECESSARY, SUPPLEMENTAL DRAWINGS SHALL BE PREPARED AND SUBMITTED BY THE CONTRACTOR.

- 39. THIS PROJECT WILL NOT BE SUBMITTED TO THE CITY COUNCIL FOR ACCEPTANCE OF IMPROVEMENTS UNTIL ALL STREET LIGHTS ARE INSTALLED AND ENERGIZED. COMPLETE AS-BUILT PLANS ARE ALSO REQUIRED PRIOR TO INSPECTION.
- 40. PER THE REQUIREMENTS OF THE PROFESSIONAL LAND SURVEYORS' ACT (BUSINESS AND PROFESSIONS CODE 8700-8805) SECTION 8771: ALL SURVEY MONUMENTS, PROPERTY PINS ETC., WITHIN THE LIMITS OF CONSTRUCTION, THAT HAVE THE POSSIBILITY OF BEING DAMAGED OR DESTROYED DURING CONSTRUCTION MUST BE LOCATED AND REFERENCED BY A LICENSED LAND SURVEYOR, AND A CORNER RECORD OR RECORD OF SURVEY SHALL BE FILED WITH THE COUNTY SURVEYOR, PRIOR TO THE START OF CONSTRUCTION. IF ANY OF THESE MONUMENTS ARE DESTROYED, DAMAGED, OR COVERED DURING THE COURSE OF CONSTRUCTION A NEW MONUMENT AND MONUMENT BOX MUST THEN BE SET IN ITS PLACE, AT THE EXACT LOCATION, BY A LICENSED LAND SURVEYOR, AND ANOTHER CORNER RECORD OR RECORD OF SURVEY FILED WITH THE COUNTY SURVEYOR. ADDITIONALLY, CONTRACTOR'S LICENSED SURVEYOR SHALL TIE DOWN EXISTING MONUMENTS AND SUBMIT THE INFORMATION TO THE ENGINEER. A NEW RECORD OF SURVEY SHALL BE FILED AT THE COUNTY'S RECORDER'S OFFICE.
- 41. THE CONTRACTOR SHALL BE RESPONSIBLE FOR CLEANING ALL TRASH AND DEBRIS 100' IN ALL DIRECTIONS OF PROJECT LIMITS, AND AROUND ALL RAILROAD TRACKS.

UPRR GENERAL NOTES

- CONTRACTORS SHALL NOTIFY SERVICE ALERT, (800) 642-2444 AND FIBER OPTICS HOTLINE (800) 336-9193, 48 HOURS PRIOR TO ANY EXCAVATION. THE USA AUTHORIZATION NUMBERS SHALL BE KEPT AT THE JOB SITE.
- 2. NO WORK WHATSOEVER SHALL BE COMMENCE WITHOUT FIRST NOTIFYING THE UPRR ENGINEER.
- 3. THE CONTRACTOR SHALL COMPLY WITH ALL FEDERAL, STATE, COUNTY, AND CITY LAWS AND ORDINANCES AND REGULATIONS OF THE DEPARTMENT OF INDUSTRIAL RELATIONS, OSHA, NPDES AND INDUSTRIAL ACCIDENT COMMISSION RELATED TO THE SAFETY AND CHARACTER OF THE WORK, EQUIPMENT AND LABOR PERSONNEL.
- 4. CONTRACTOR SHALL BE RESPONSIBLE FOR COORDINATING WITH ALL UTILITY AGENCIES.
- 5. CONTRACTOR SHALL PROTECT IN PLACE (BY ANY MEANS NECESSARY) ALL EXISTING UTILITIES TO REMAIN UNLESS OTHERWISE SPECIFIED HEREIN, CONTRACTOR SHALL BE RESPONSIBLE FOR THE COMPLETE REPAIR AT HIS EXPENSE, FOR ANY DAMAGE TO EXISTING UTILITIES, STRUCTURES, OR OTHER SITE FEATURES, AS A RESULT OF HIS WORK.
- 6. PRIOR TO PLACING CURBS, PAVEMENTS, BASE, SUBBASE, TRACK, ETC., ALL UNDERGROUND UTILITIES SHALL BE INSTALLED, BACKFILL COMPLETED, AND THE ENGINEER NOTIFIED BY EACH OF THE UTILITY COMPANIES HAVING FACILITIES WITHIN THE WORK AREA, THAT THE UTILITY INSTALLATION HAS SATISFACTORILY PASSED ACCEPTANCE TESTS.
- 7. ALL EXISTING UNDERGROUND UTILITIES, THAT ARE NOT TO BE RE-USED SHALL BE ABANDONED IN PLACE. ALL EXISTING PIPELINES TO BE ABANDONED IN PLACE SHALL BE CEMENT SLURRY FILLED AND CAPPED AT LEAST 3'-0" BELOW TOP OF PROPOSED SUBGRADE, UNLESS OTHERWISE
- 8. CONTRACTOR SHALL VERIFY LOCATIONS AND ELEVATIONS OF EXISTING UTILITIES WHETHER KNOWN OR UNKNOWN PRIOR TO BEGINNING CONSTRUCTION.
- 9. ANY UNDERGROUND STRUCTURES SUCH AS CESSPOOLS, CISTERNS, MINING SHAFTS, TUNNELS, SEPTIC TANKS. WELLS. AND PIPELINES NOT LOCATED PRIOR TO CONSTRUCTION SHALL BE BROUGHT TO THE ATTENTION OF THE ENGINEER FOR DETERMINATION OF APPROPRIATE ACTION SUCH AS REMOVAL OR TREATMENT IN A MANNER JUDGED SUITABLE TO THE ENGINEER.
- 10. CONTRACTOR SHALL COORDINATE LOCATION OF ALL PROPOSED UTILITIES WITH UPRR TO ASSURE ACCURACY OF UTILITY CONNECTIONS AND COMPLIANCE WITH LOCAL CODES.
- 11. ANY EXISTING CONDITIONS FOUND TO BE A VARIANCE WITH THESE DRAWINGS MUST BE IMMEDIATELY REPORTED TO THE ENGINEER.
- CONTRACTOR SHALL MAINTAIN AND CLEAN TO THE SATISFACTION OF THE ENGINEER, ALL ACCESS AND SERVICE ROADS USED DURING CONSTRUCTION.
- 13. CONTRACTOR SHALL PERFORM ALL CONSTRUCTION IN SUCH A MANNER AS TO PROTECT ADJACENT EXISTING BUILDINGS, AND OTHER SITE ELEMENTS WHICH ARE TO REMAIN IN SERVICE.
- 14. CONTRACTOR SHALL PROVIDE AS-BUILT DRAWINGS FOR ALL IMPROVEMENTS.
- 15. NO FIELD CHANGES WILL BE PERMITTED WITHOUT DIRECT WRITTEN AUTHORIZATION FROM THE UPRR ENGINEER OR HIS REPRESENTATIVE.
- 16. CONTRACTOR SHALL COORDINATE WORK WHICH AFFECTS ADJACENT PROPERTY OWNERS. ANY QUESTIONS OR AGREEMENTS BETWEEN ADJACENT PROPERTY OWNERS AND CONTRACTOR SHALL BE MADE IN WRITING. A COPY OF SUCH AGREEMENT SHALL BE PROVIDED TO THE UPRR ENGINEER OR HIS REPRESENTATIVE.
- 17. THE CONTRACTOR IS RESPONSIBLE FOR PREPARING A STORMWATER POLLUTION PREVENTION PLAN (SWPPP) TO COMPLY WITH CALIFORNIA REGULATIONS. GENERAL SPECIFICATIONS AND TYPICAL EROSION CONTROL DETAILS ARE INCLUDED IN THE PLAN SET.
- 18. RIGHT-OF-WAY LINES SHOWN ON THE PLANS WERE TAKEN FROM EXISTING UPRR RIGHT-OF-WAY MAP AND ARE APPROXIMATE.
- 19. THE CONTRACTOR IS RESPONSIBLE FOR THE REMOVAL OF ALL PAVEMENT MARKINGS THAT WILL BE IN CONFLICT WITH THE PROPOSED WORK.
- 20. CONTRACTOR SHALL MAINTAIN AT LEAST ONE ACCESS TO ALL AFFECTED BUSINESS. IF NECESSARY, MULTIPHASE CONSTRUCTION SHALL BE UTILIZED.

TRAFFIC NOTES

- 1. ALL BARRICADES, WARNING SIGNS, LIGHTS, DEVICES, ETC. FOR THE GUIDANCE OF VEHICLE TRAFFIC AND PEDESTRIANS MUST CONFORM TO THE INSTALLATION SHOWN IN THE MANUAL ON UNIFORM TRAFFIC CONTROL DEVICES (MUTCD), CURRENT EDITION.
- 2. CONTRACTOR SHALL MAKE TWICE DAILY INSPECTIONS OF BARRICADES AND FLASHING LIGHTS TO ENSURE PROPER PLACEMENT AND FUNCTIONING OF WARNING DEVICES.
- 3. GRADE CROSSINGS CLOSED TO TRAFFIC DURING CONSTRUCTION SHALL BE BARRICADED IN ACCORDANCE WITH THE M.U.T.C.D. AND F.R.A.
- 4. AT ALL GRADE CROSSINGS, ALL GRADE CROSSING WARNING SIGNS (CROSSBUCK) SHALL TEMPORARILY BE RELOCATED DURING CONSTRUCTION AND RESET AFTER THE GRADE CROSSINGS CONSTRUCTION IS COMPLETED TO A POINT ADJACENT TO THE ROADWAY AND 15 FEET FROM THE CENTERLINE OF THE NEAR TRACK AS SLATED IN THE MUTCD EXCEPT WHERE AUTOMATIC GRADE CROSSING WARNING SIGNALS/GATES EXIST. ALL AUTOMATIC WARNING DEVICES ARE THE RESPONSIBILITY OF UPRR. AT NO TIME SHALL A CROSSING BE LEFT OPEN WITHOUT PROPER WARNING SIGNS IN PLACE.
- CONTRACTOR SHALL SUBMIT TRAFFIC CONTROL PLANS TO CITY OF STOCKTON AND SAN JOAQUIN COUNTY FOR APPROVAL AT LEAST 2 WEEKS PRIOR TO EACH ROAD CLOSURE. PLANS SHALL BE 11"X17" ENGINEERED DRAWINGS, SEALED BY A PROFESSIONAL ENGINEER FOR THE STATE OF CALIFORNIA.
- 6. THE CONTRACTOR IS RESPONSIBLE FOR THE PROMPT REPLACEMENT AND/OR REPAIR OF ALL TRAFFIC CONTROL DEVICES AND APPURTENANCES DAMAGED OR DISTURBED DUE TO CONSTRUCTION.

STRIPING NOTES:

REFER TO SHEET SS-1, SIGNING AND STRIPING PLAN, FOR STRIPING NOTES.

TRAFFIC SIGNAL PLAN NOTES:

REFER TO SHEET GN-1, TRAFFIC SIGNAL PLAN, FOR TRAFFIC SIGNAL NOTES

SPECIFICATIONS:

REFER TO THE SPECIAL PROVISIONS FOR ASPHALT CONCRETE, AGGREGATE BASE, GEOSYNTHETICS (ALTERNATIVE), PIPE MATERIALS, BEDDING, TRENCHING, AND EXCAVATION, AND ALL ELECTRICAL WORK (INCLUDING BUT NOT LIMITED TO SIGNALS, EQUIPMENT, ETC.).

ALL SPECIFICATIONS SHALL ADHERE TO CITY OF STOCKTON (ELECTRICAL AND SIGNAL WORK, ETC.); CALTRANS AND SAN JOAQUIN COUNTY (PAVING, TRENCHING, EXCAVATION, ETC.)

CONTACT LIST

H) RAILROAD

A) REGULATORY AGENCY: CITY OF STOCKTON 22 E. WEBER AVENUE STOCKTON, CA 95202 209-937-8411

> SAN JOAQUIN COUNTY 1810 E. HAZELTON AVENUE STOCKTON, CA 95205

209-468-3000 B) WATER CALIFORNIA WATER SERVICE COMPANY

209-464-8311

1550 W. FREMONT STREET, SUITE 100 STOCKTON, CA 95203

C) GAS & ELECTRIC: P. G. & E. 4040 WEST LANE STOCKTON, CA 95204 209-942-1489

D) TELEPHONE: 3706 E. HAMMER LANE, SUITE 6 STOCKTON, CA 95212

209-474-4364 E) CABLE TELEVISION: COMCAST 6505 TAM O'SHANTER DRIVE


STOCKTON, CA 95210 209-993-6685

CITY OF STOCKTON M.U.D. F) SEWER: 2500 NAVY DRIVE STOCKTON, CA 95206

209-937-8341 CENTURYLINK/QWEST;MCI;LEVEL 3 AND SPRINT G) FIBER OPTIC 800-336-9193

UNION PACIFIC RAILROAD 1400 DOUGLAS ST. OMAHA, NE 68179 402-544-3330



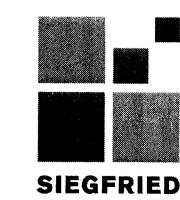

Stockton, California 95219

UNION PACIFIC E RAILROAD CHECKED BY: P.IS LOCATION & DESCRIPTION: DATE:

SHEET TITLE:

07/12/2016


SHEET NUMBER

G002

Office of Assistant Vice President **Engineering Design/Construction**

Stockton, California Oakland Subdivision MP 90.37

Industrial Drive/McKinley Avenue and UPRR Crossing Safety Improvements **GENERAL NOTES AND SPECIFICATIONS**

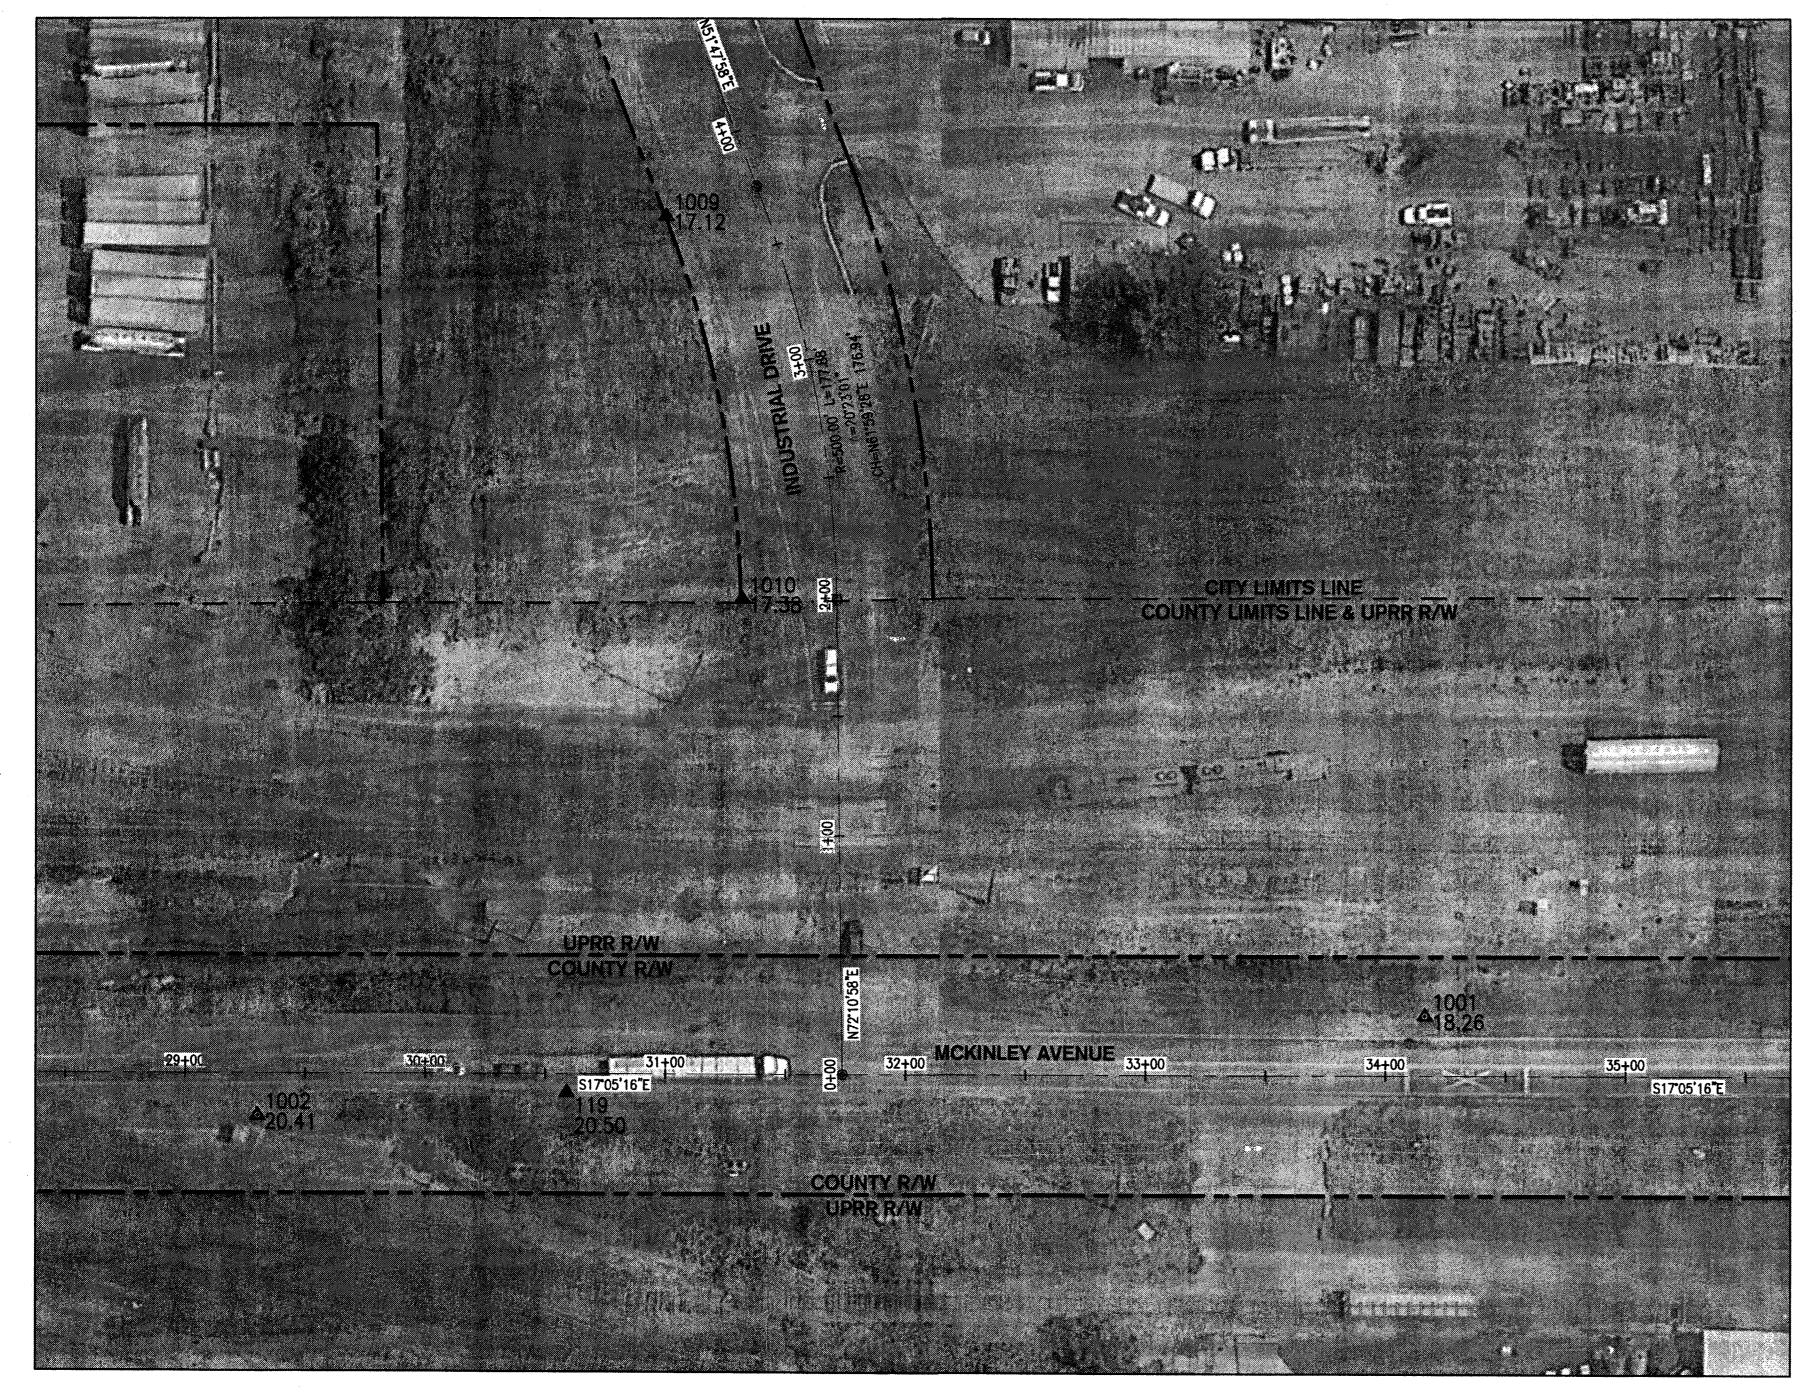

PROPOSED TELEPHONE LINE TOP OF CURB ELEVATION PAVEMENT ELEVATION 11.93TC 11.43FL PAVEMENT ELEVATION TOP OF DITCH ELEVATION TOE OF DITCH ELEVATION FLOWLINE ELEVATION BENCHMARK MONUMENT FOUND GATE VALVE FIRE HYDRANT CENTERLINE MONUMENT UTILITY POLE ELECTRICAL BOX UTILITY VAULT CURVE DATA CALLOUT NOTE CALLOUT DETAIL _ NUMBER DETAIL REFERENCE

LEGEND

ABBREVIATIONS

	,,,,,,,,,,,,,,,,,,,,,,,,,,,,,,,,,,,,,
<u>ABBREVIATION</u>	DESCRIPTION
1	
0	AT
AB .	AGGREGATE BASE
AC	ASPHALT CONCRETE
ADA	AMERICANS WITH DISABILITIES ACT
BC	BEGINNING OF CURVE
BLDG.	BUILDING
BOC	BACK OF CURB
BW	BACK OF WALK
COL	COLUMN
C	CONCRETE
C,G, & SW	CURB, GUTTER, AND SIDEWALK
CL	CENTERLINE
CB	CATCH BASIN
co	CLEANOUT
C.O.S.	CITY OF STOCKTON
CPUC	CALIFORNIA PUBLIC UTILITIES COMMISSION
DIA	DIAMETER
DIP	DUCTILE IRON PIPE
DWG	DRAWING
EC	END OF CURVE
ĒĽ	ELEVATION
EP	EXISTING PAVEMENT
ESMT	EASEMENT
EX.	EXISTING
Į į̇̃.	FLOWLINE
l if	FINISHED FLOOR
FOC	FACE OF CURB
FH	FIRE HYDRANT
FTG	FOOTING
• • •	GROUND
G GB	GRADE BREAK
GB GI	
	GALVANIZED IRON
HP HODIZ	HIGH POINT
HORIZ	HORIZONTAL
INV	INVERT
i.e.	LINEAL FEET
L L	LEFT
MAX	MAXIMUM
МН	MAINTENANCE HOLE
MIN	MINIMUM
NO.	NUMBER
NTS	NOT TO SCALE
P	PAVEMENT
PC	POINT OF CURVATURE
PP	POWER POLE
PT	POINT
PUE	PUBLIC UTILITY EASEMENT
PVC	POLYVINYL CHLORIDE
PL	PROPERTY LINE
R	RADIAL OR RADIUS
R/W	RIGHT-OF-WAY
RC	ROLL-CURB
RCP	REINFORCED CONCRETE PIPE
RWL	RAIN WATER LEADER
SD	STORM DRAIN
SS	SANITARY SEWER
SL	STREET LIGHT
SW	SIDEWALK
SDJB	STORM DRAIN JUNCTION BOX
SDMH	STORM DRAIN MAINTENANCE HOLE
SSMH	SANITARY SEWER MAINTENANCE HOLE
STA	STATION
STD	STANDARD
ST	STREET
TC	TOP OF CURB
П	TRAFFIC INDEX
TW	TOP OF WALL
TYP	TYPICAL
U.O.N.	UNLESS OTHERWISE NOTED
UPRR	UNION PACIFIC RAILROAD
V	UNDERGROUND VAULT
VAR	VAR
VC	VERTICAL CURVE
VERT	VERTICAL
W	WATER
. ws	WATER SERVICE
(W)	WEST
(E)	EAST
(S)	SOUTH
(N)	NORTH
± (1)	PLUS OR MINUS
(L)	LEFT SIDE OF ROAD
(R)	RIGHT SIDE OF ROAD

HORIZONTAL CONTROL PLAN
SCALE: 1" = 40'



POINT	NORTHING	EASTING	ELEVATION	DESCRIPTION
119	2153626.31	6338383.87	20.50	MONUMENT FOUND 2.5" RCE 8189 C.O.S. 3S-2
1001	2153294.31	6338520.60	18.26	MONUMENT SET 1" REBAR CONTROL POINT
1002	2153746.48	6338336.51	20.41	MONUMENT SET 1" REBAR CONTROL POINT
1009	2153694.87	6338746.81	17.12	MONUMENT FOUND ½" REBAR
1010	2153617.22	6338602.36	17.38	MONUMENT FOUND 1 REBAR


BENCHMARK: CITY OF STOCKTON BENCHMARK NO. 119

BRASS DISK MARKING C.O.S. MONUMENT STAMPED "3S-2" IN MONUMENT WELL ON THE WEST SIDE OF McKINLEY AVENUE AT THE APPROXIMATE CENTERLINE OF INDUSTRIAL DRIVE, EAST OF THE WESTERN PACIFIC R.R. R/W, EXTENDED WESTERLY.

ELEVATION = 20.50

DATUM = NAVD 88 (2008 REVISION, CITY OF STOCKTON)



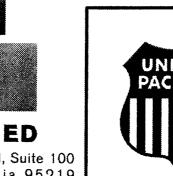

UNI	ON
PACI	IFIC

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CHECKED BY:


UNION PACIFIC
RAILROAD PJS LOCATION & DESCRIPTION:

07/12/2016 SHEET NUMBER


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Office of Assistant Vice President Engineering Design/Construction


Stockton, California
Oakland Subdivision MP 90.37
Industrial Drive/McKinley Avenue and UPRR Crossing Safety Improvements SHEET TITLE: **LEGEND AND ABBREVIATIONS**

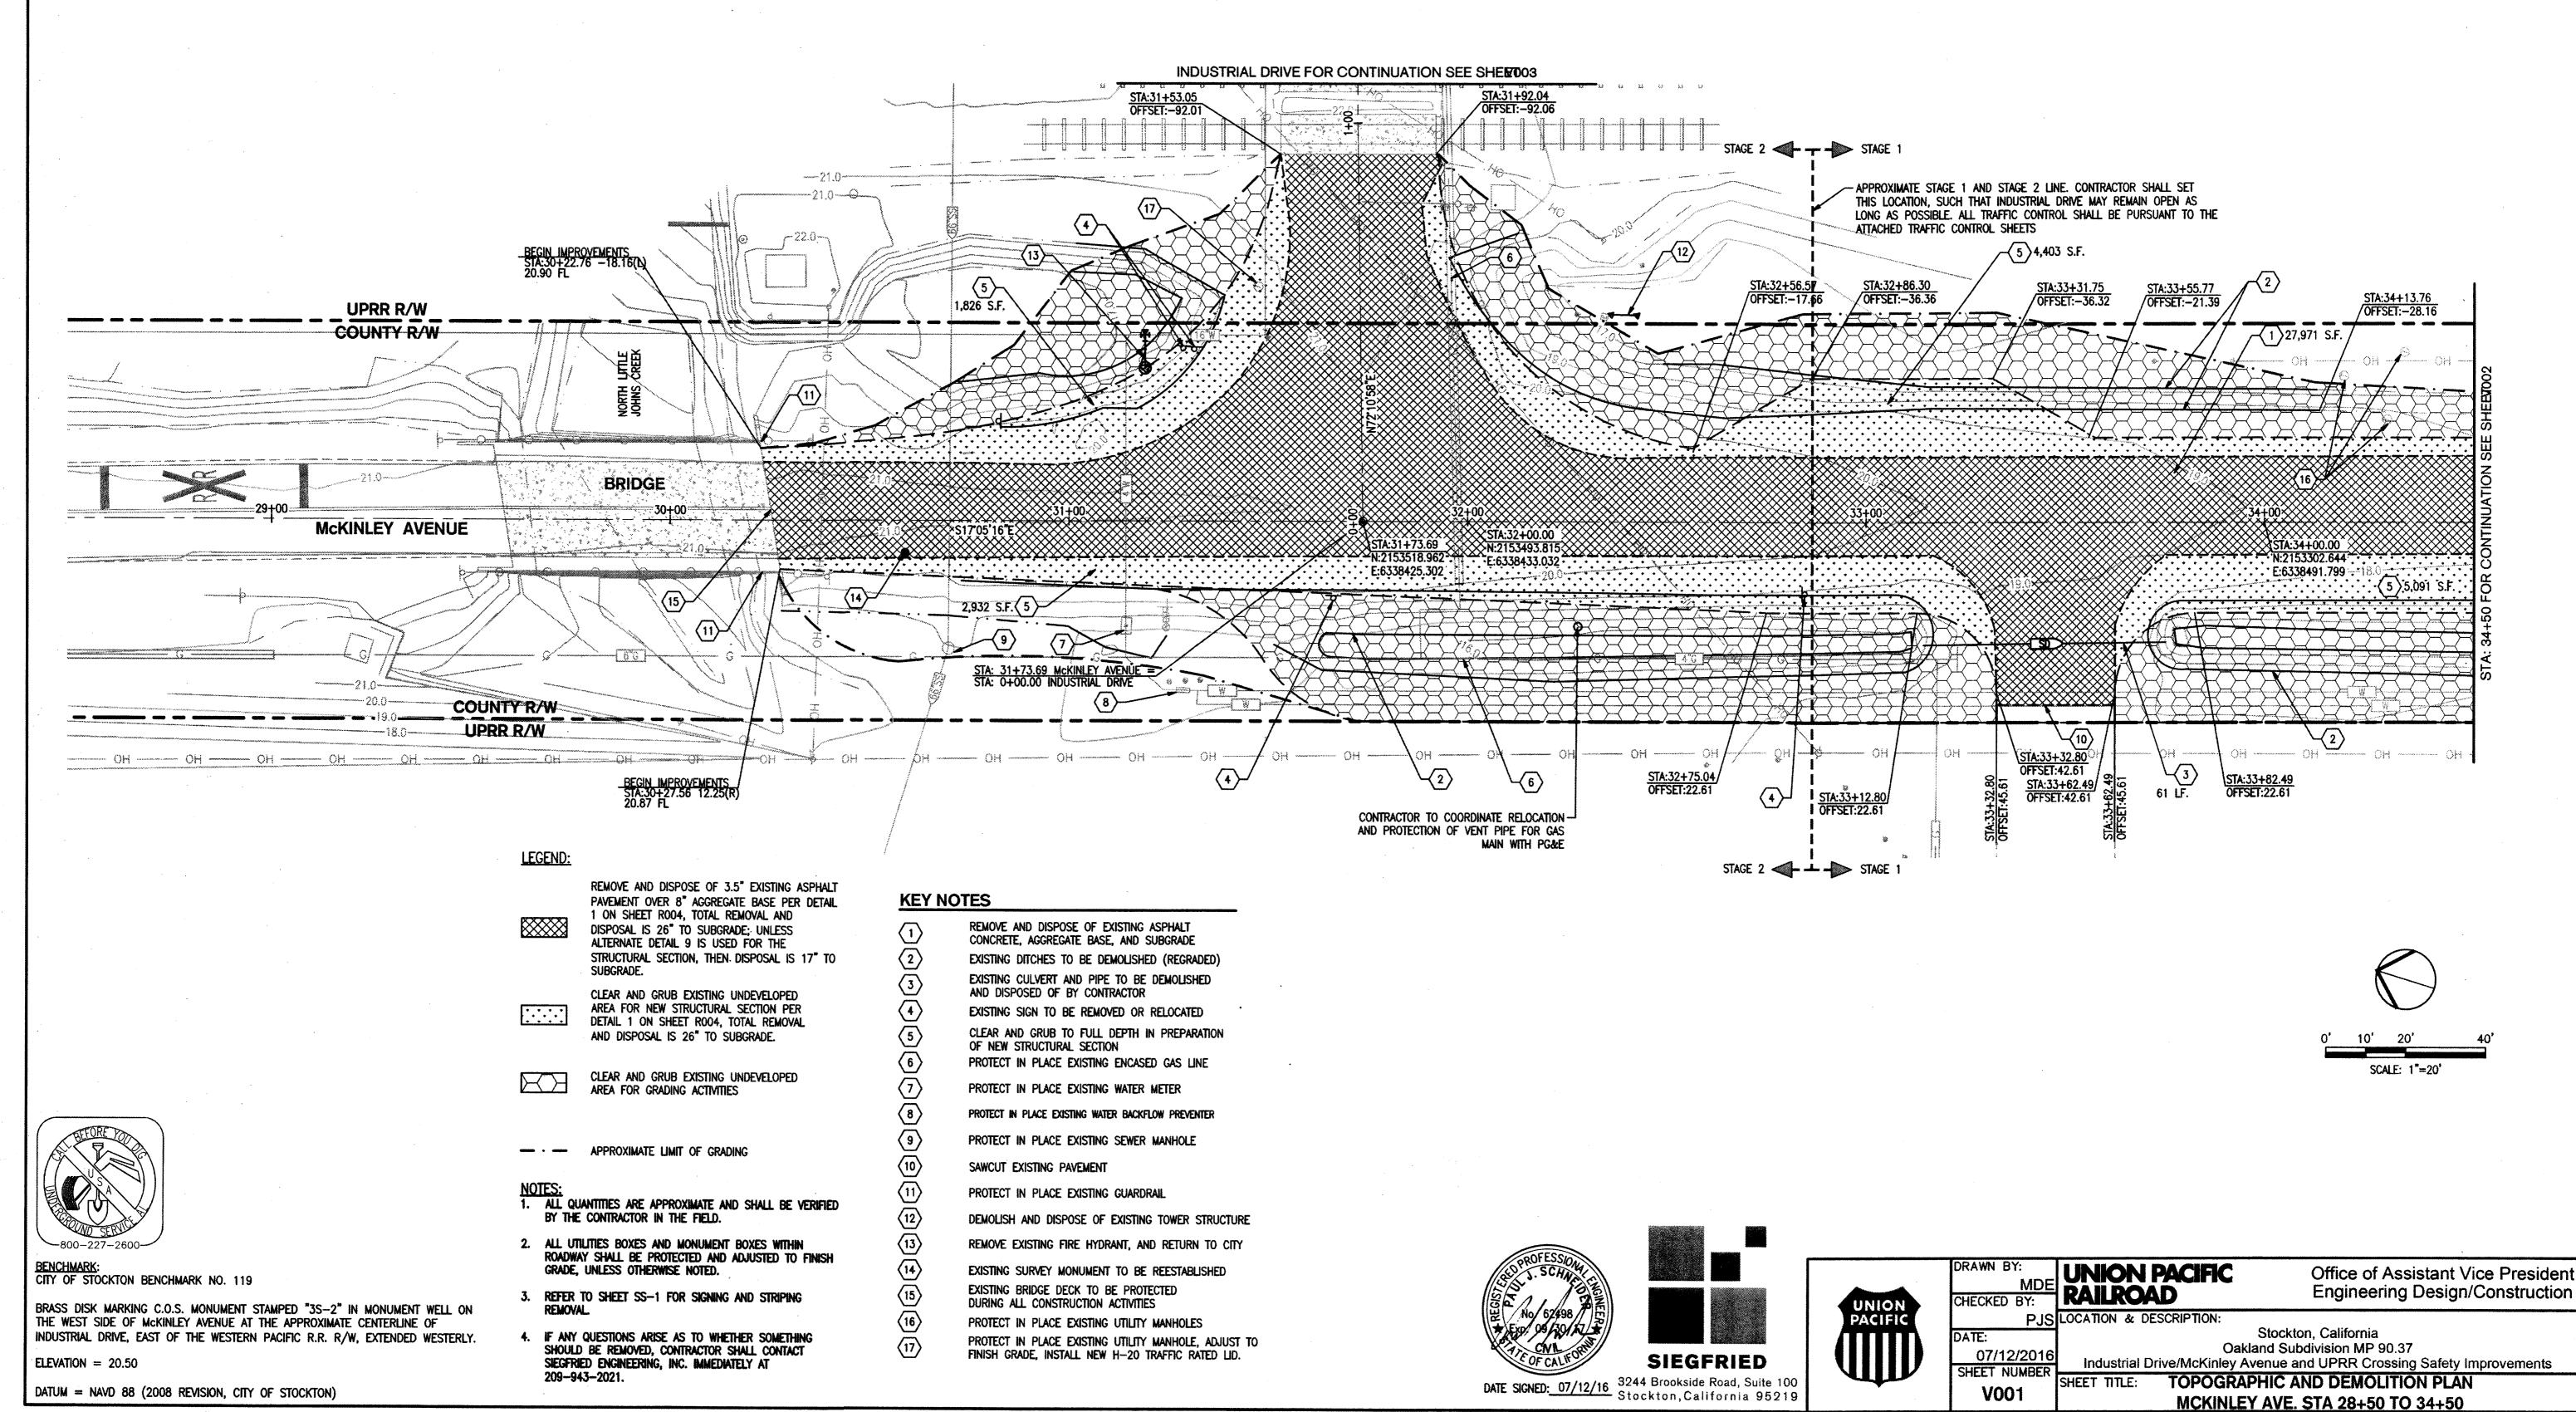

5261.30

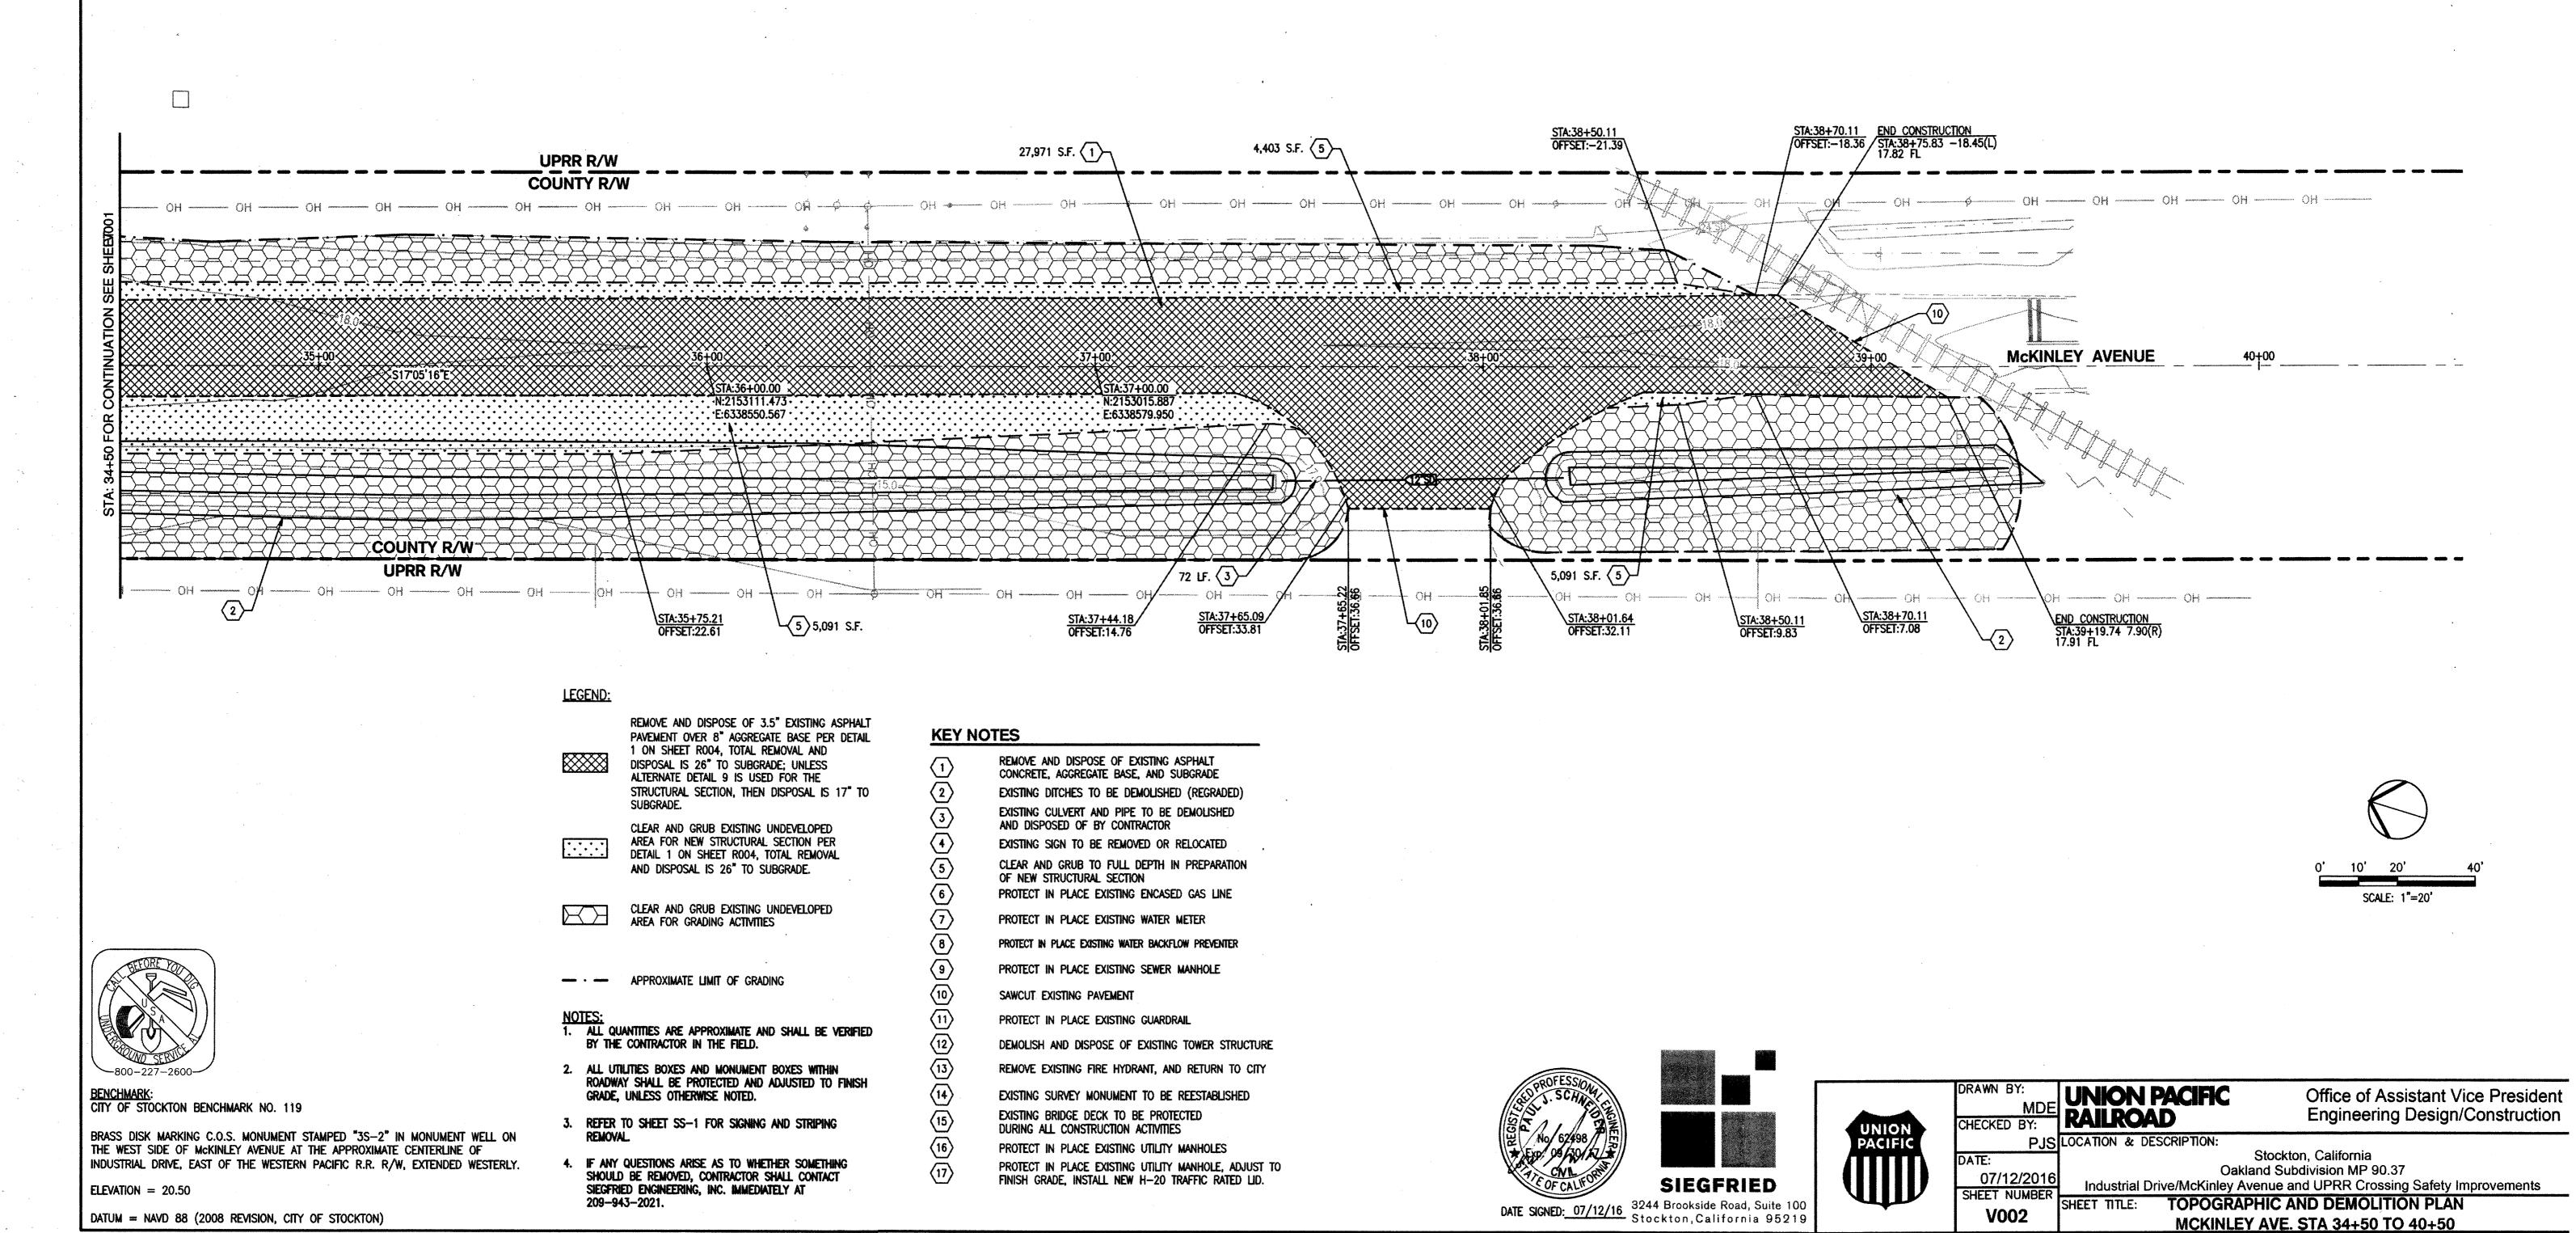

5261.40

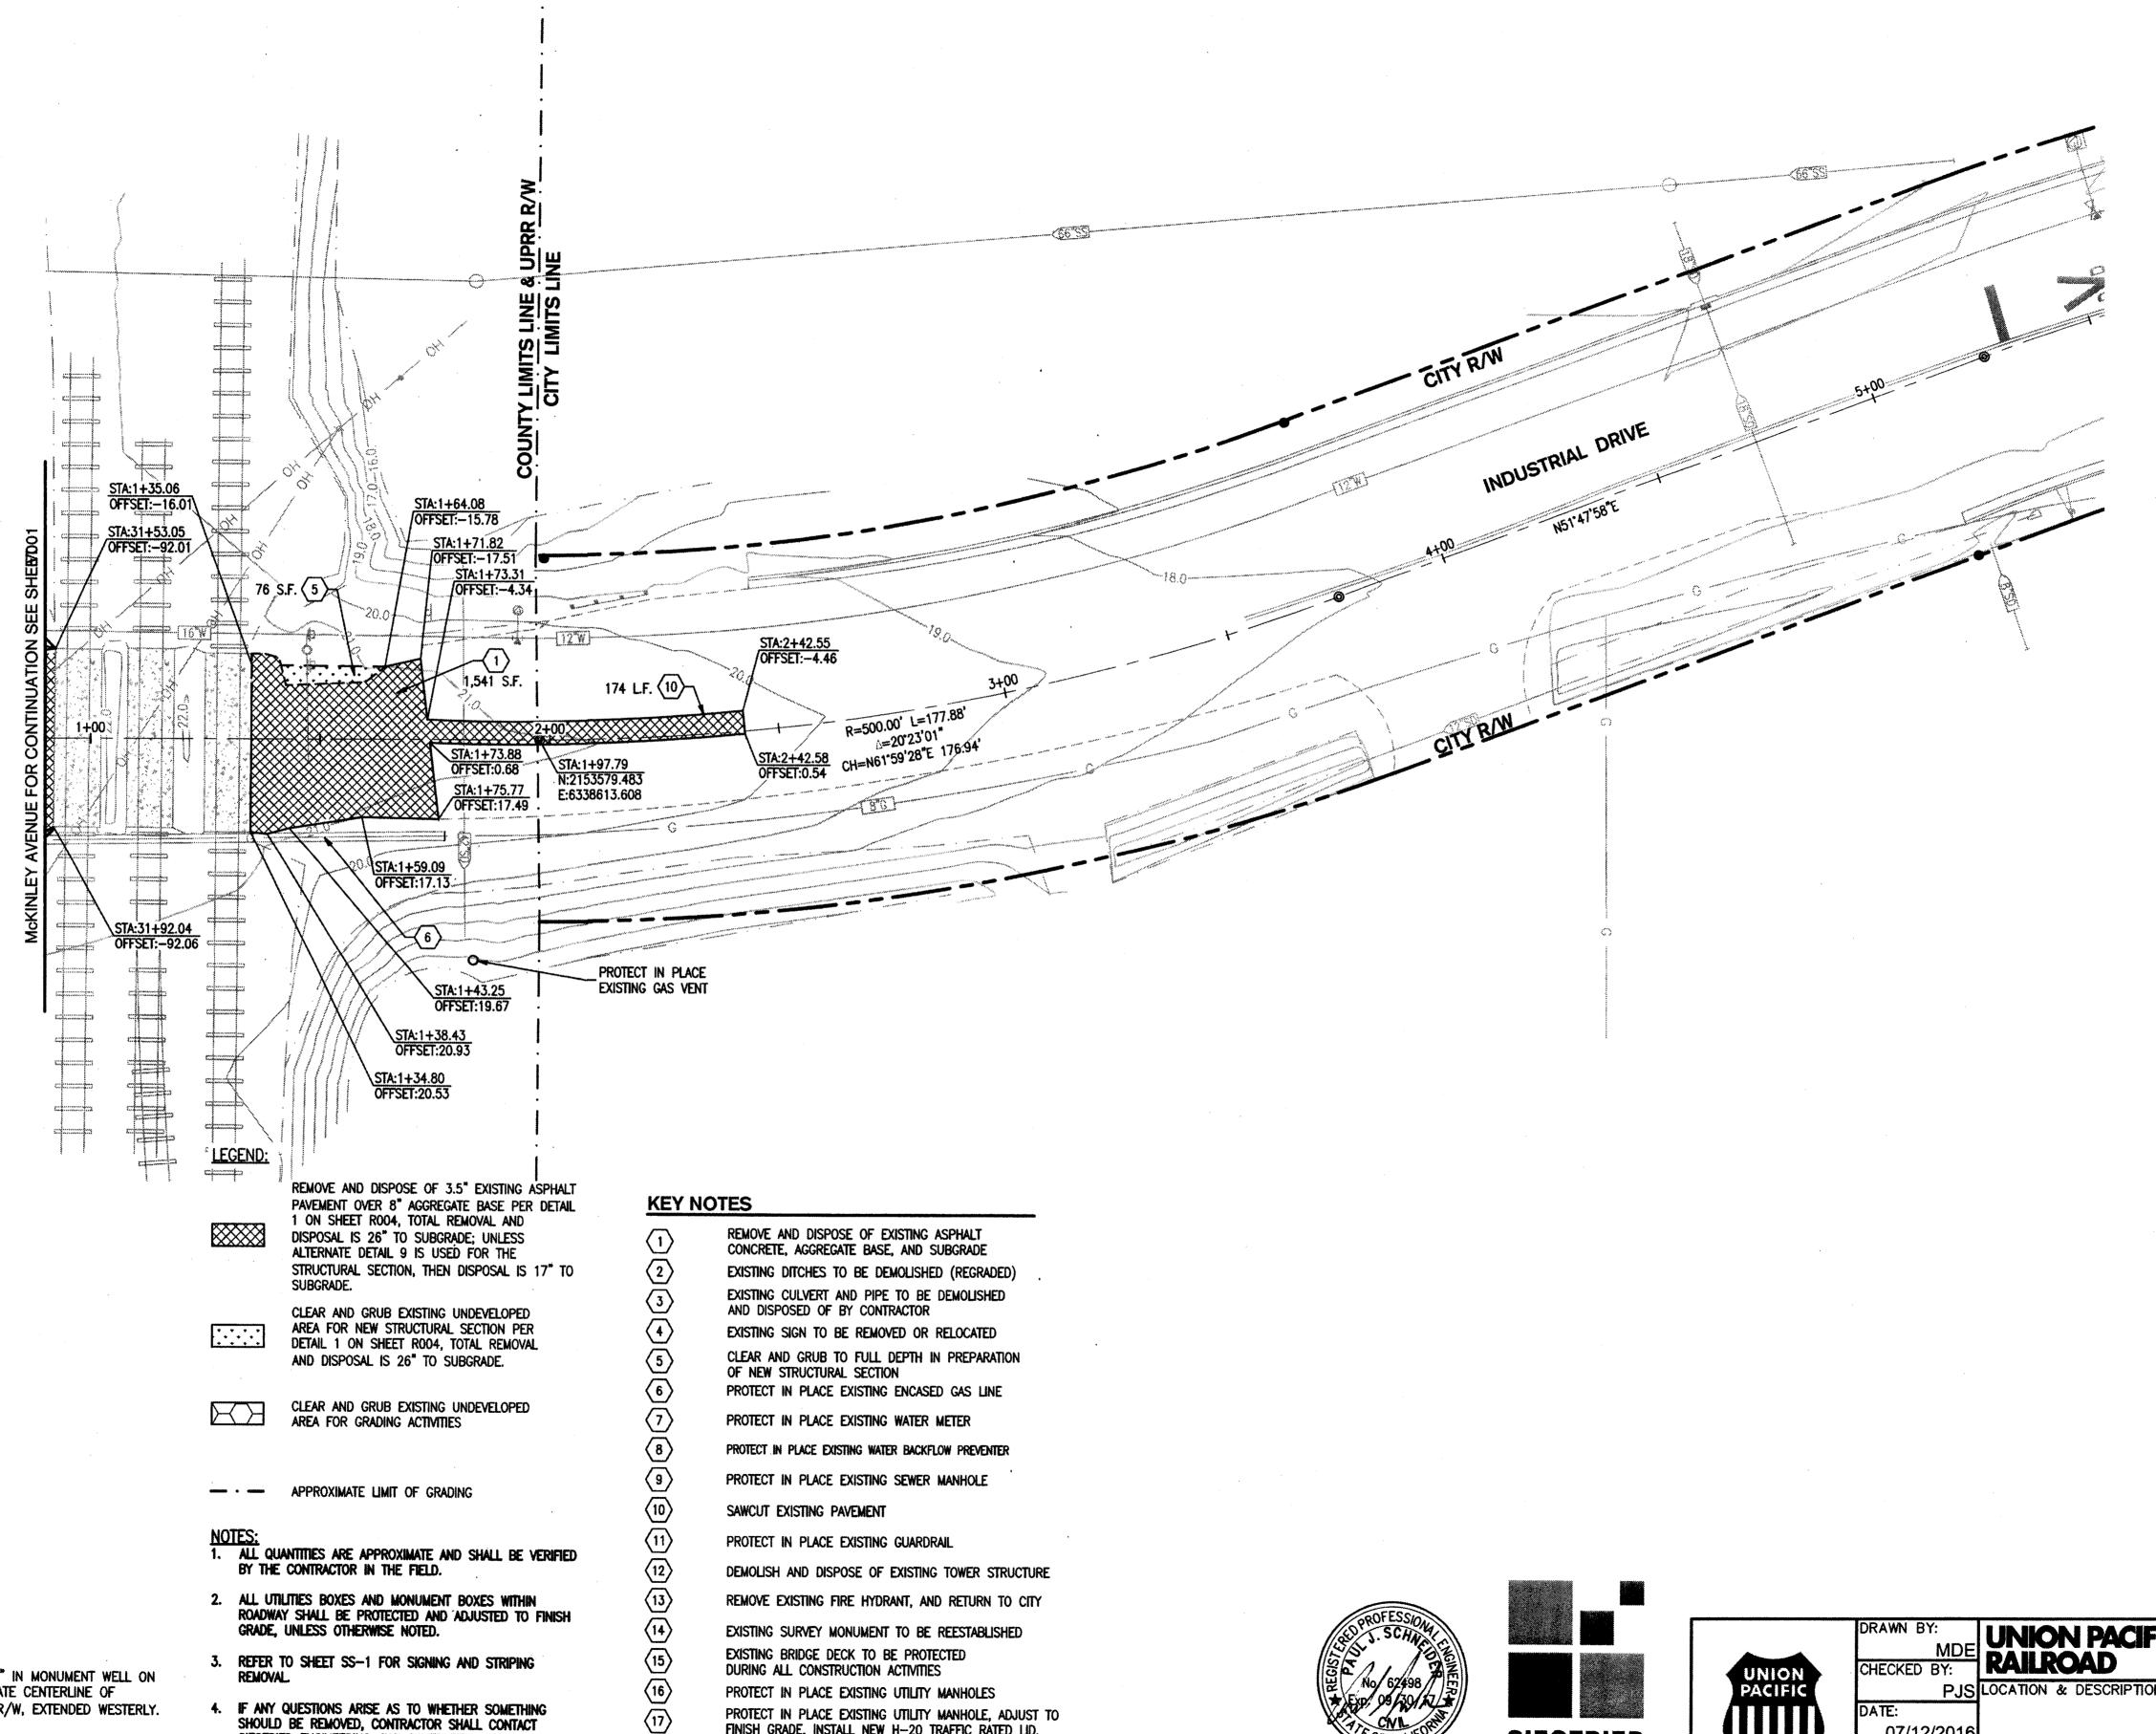



BENCHMARK: CITY OF STOCKTON BENCHMARK NO. 119

BRASS DISK MARKING C.O.S. MONUMENT STAMPED "3S-2" IN MONUMENT WELL ON THE WEST SIDE OF MCKINLEY AVENUE AT THE APPROXIMATE CENTERLINE OF INDUSTRIAL DRIVE, EAST OF THE WESTERN PACIFIC R.R. R/W, EXTENDED WESTERLY.

ELEVATION = 20.50

DATUM = NAVD 88 (2008 REVISION, CITY OF STOCKTON)

EXISTING SURVEY MONUMENT TO BE REESTABLISHED EXISTING BRIDGE DECK TO BE PROTECTED

DURING ALL CONSTRUCTION ACTIVITIES PROTECT IN PLACE EXISTING UTILITY MANHOLES PROTECT IN PLACE EXISTING UTILITY MANHOLE, ADJUST TO

3. REFER TO SHEET SS-1 FOR SIGNING AND STRIPING

4. IF ANY QUESTIONS ARISE AS TO WHETHER SOMETHING

SIEGFRIED ENGINEERING, INC. IMMEDIATELY AT

SHOULD BE REMOVED, CONTRACTOR SHALL CONTACT


REMOVAL.

209-943-2021.

FINISH GRADE, INSTALL NEW H-20 TRAFFIC RATED LID.



DATE SIGNED: 07/12/16 3244 Brookside Road, Suite 100 Stockton, California 95219

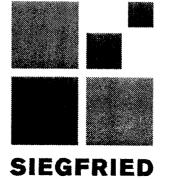

MDE CHECKED BY: UNION PACIFIC RAILROAD PJS LOCATION & DESCRIPTION:

07/12/2016

SHEET NUMBER

V003


Office of Assistant Vice President Engineering Design/Construction


SCALE: 1"=20'

Stockton, California Oakland Subdivision MP 90.37

Industrial Drive/McKinley Avenue and UPRR Crossing Safety Improvements TOPOGRAPHIC AND DEMOLITION PLAN INDUSTRIAL DR. STA 1+00 TO 5+50

5261.5C

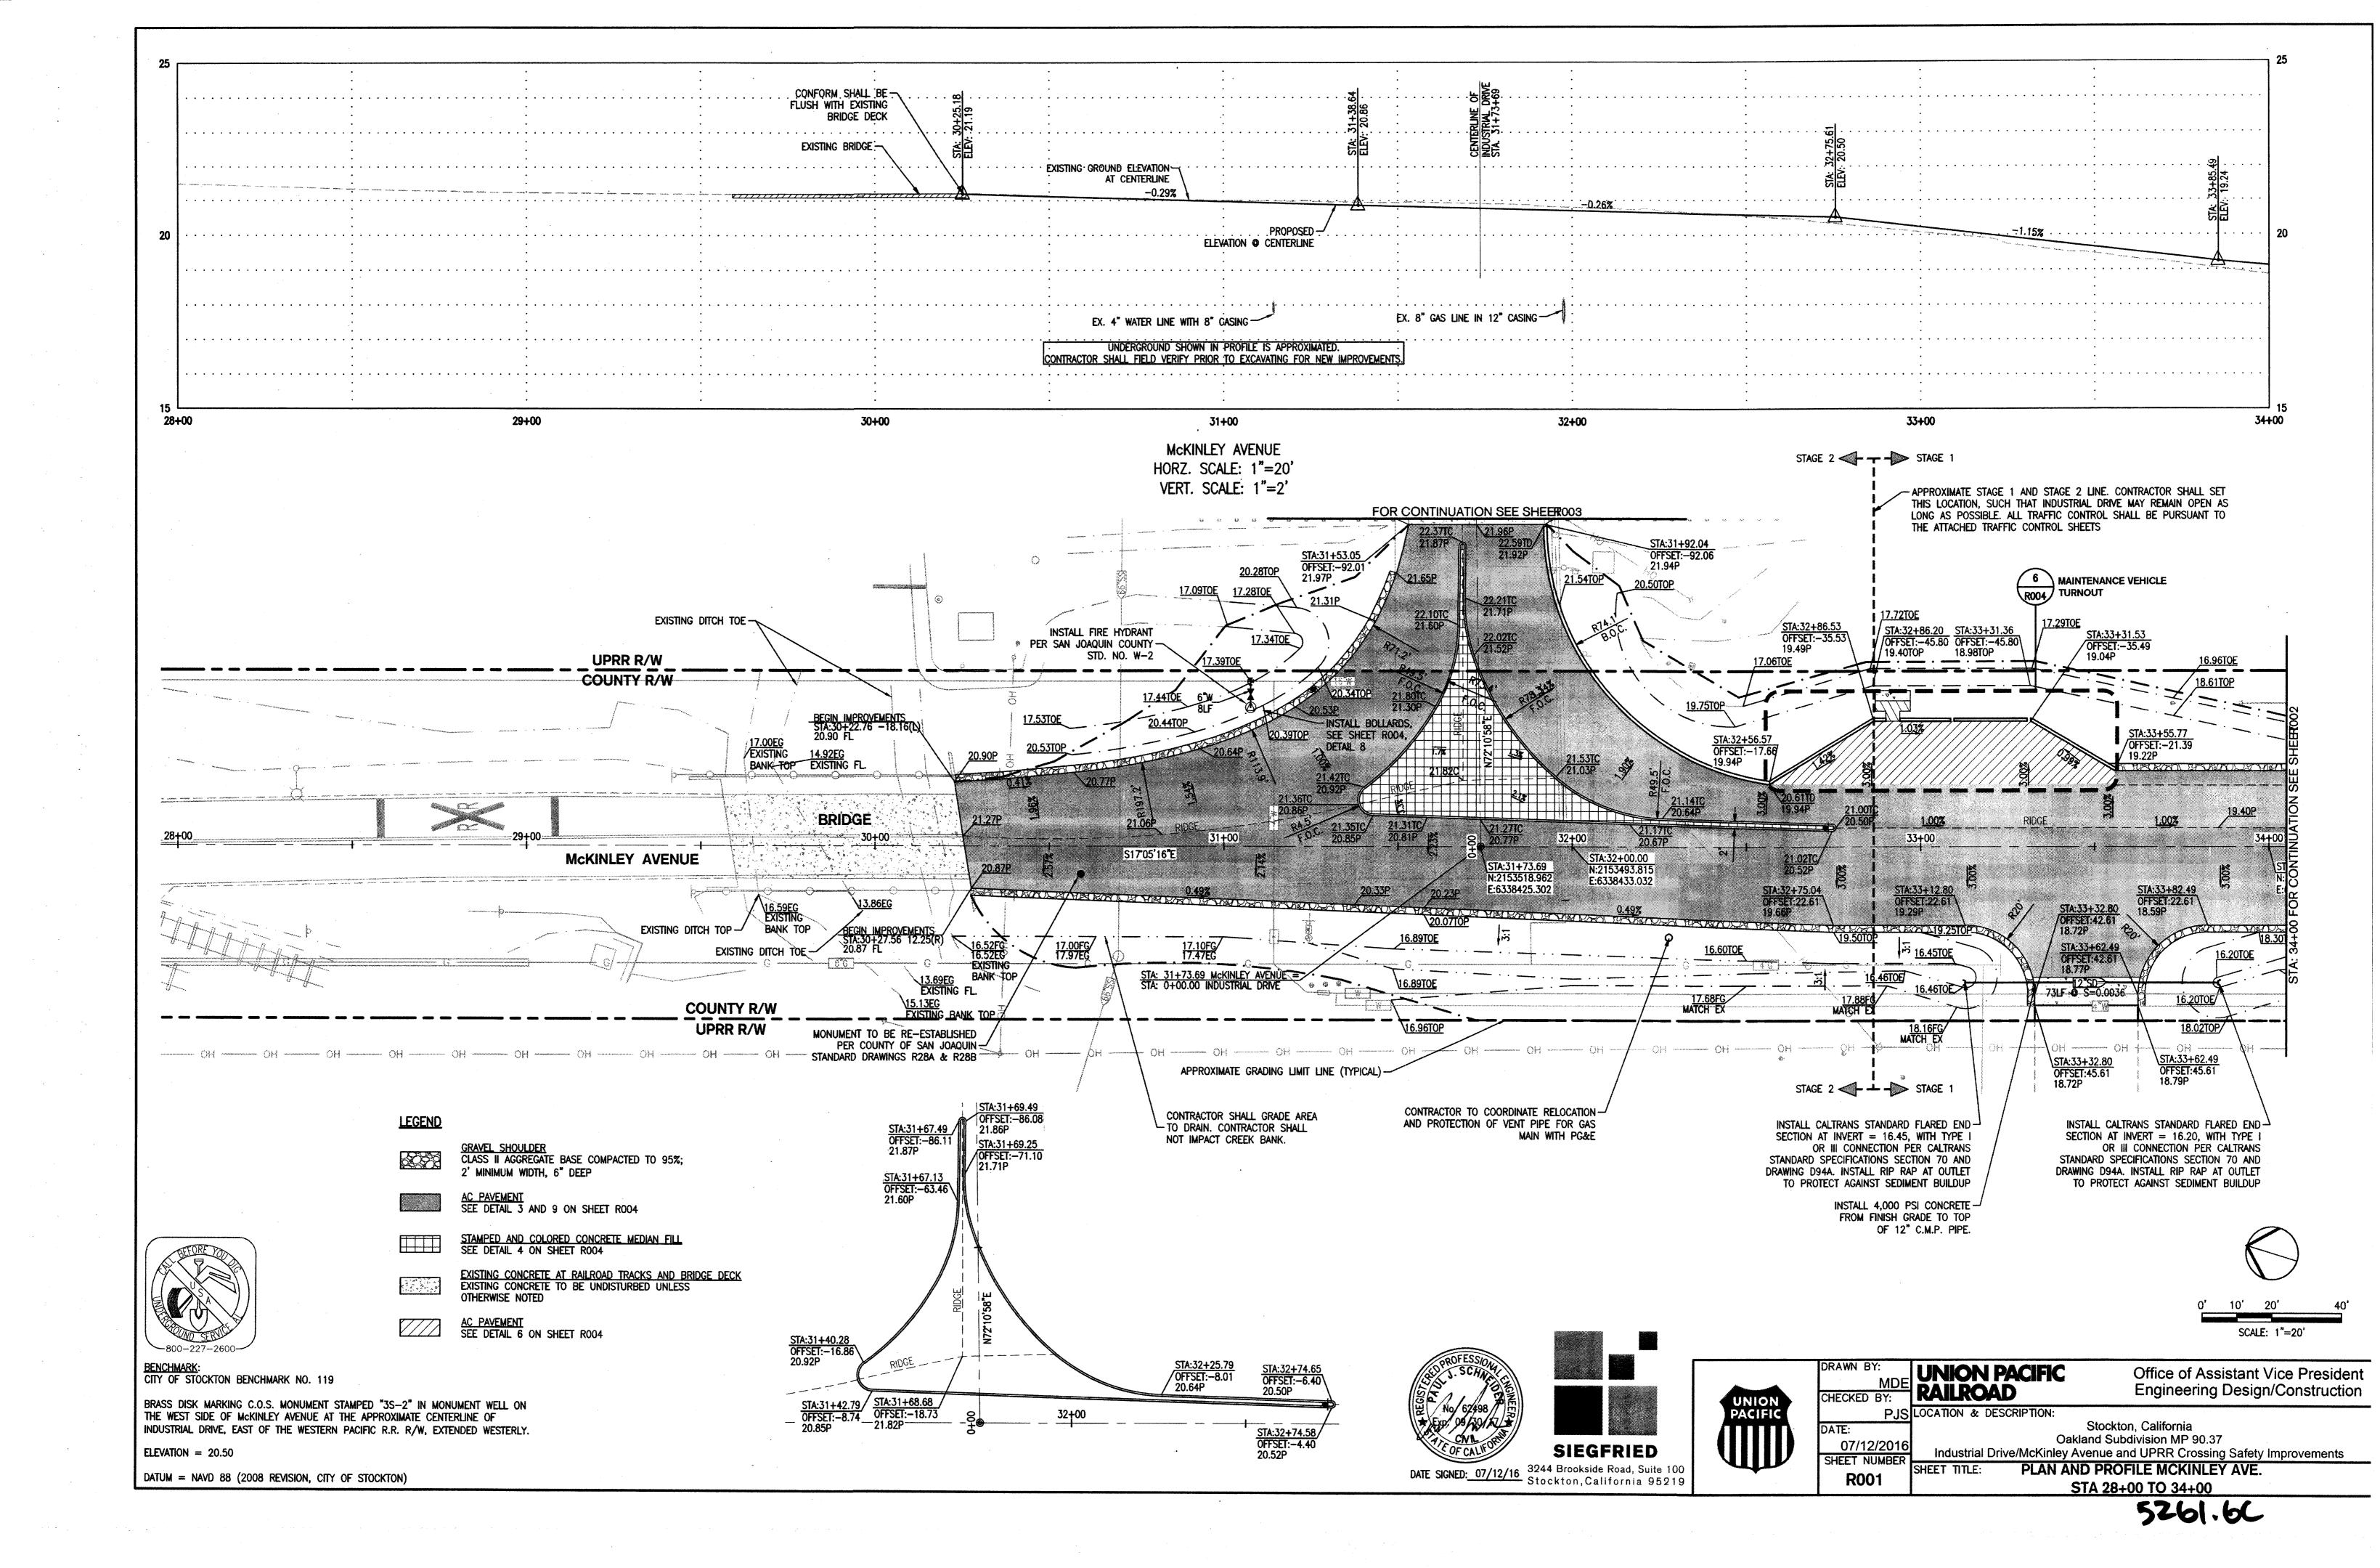

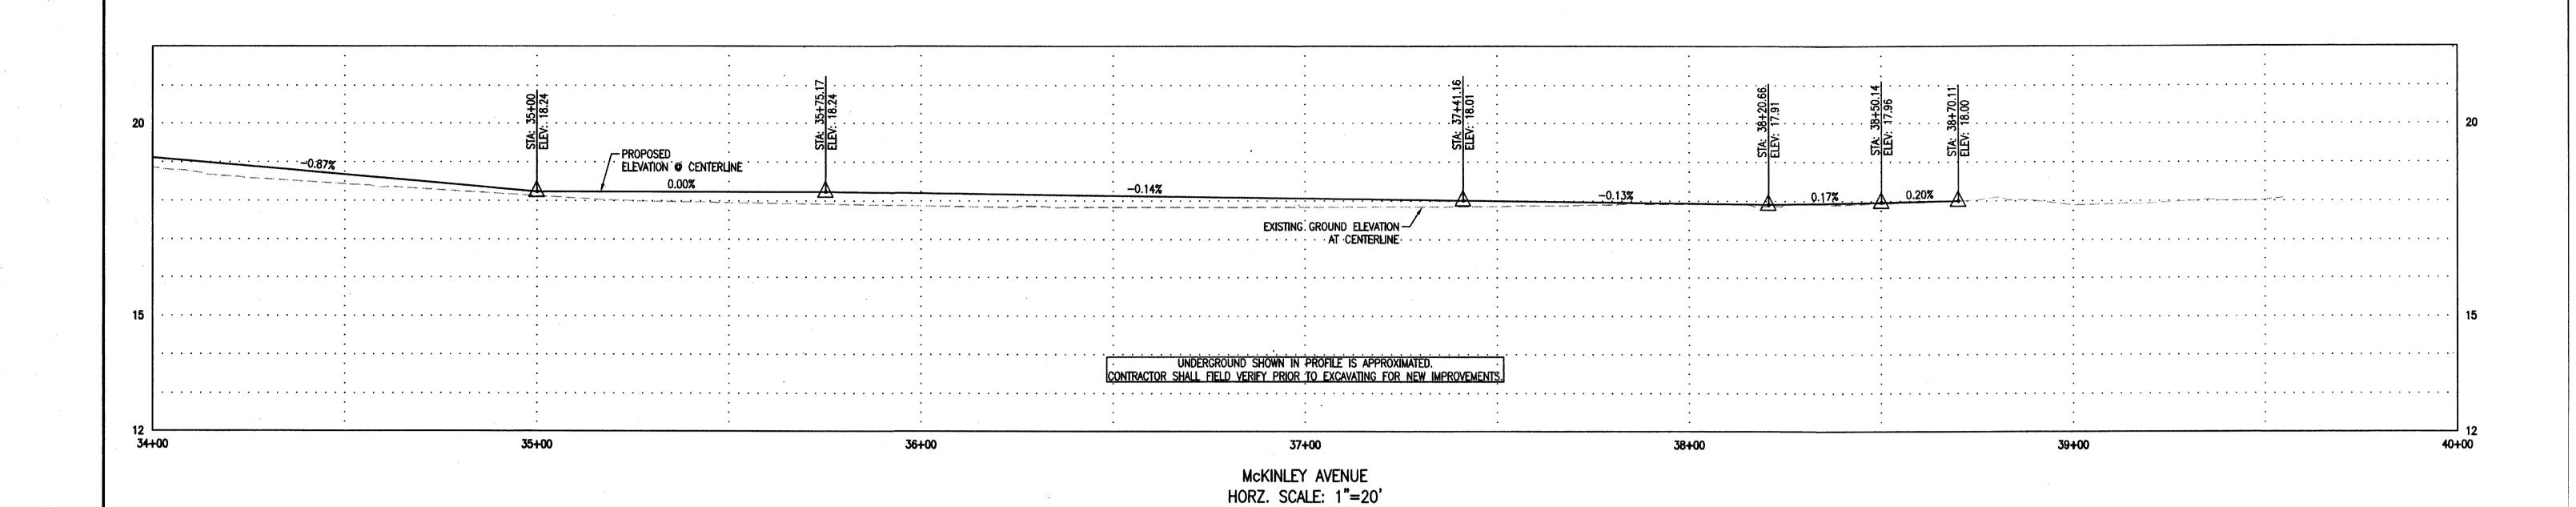

VERT. SCALE: 1"=2"

18.40P 35+00 38+00 36+00 37+00 S17'05'16"E STA:34+00.00 N:2153302.644 E:6338491.799 STA:36+00.00 N:2153111.473 STA:37+00.00 N:2153015.887 STA:38+70.11

STA:38+70.11

17.49TOP

OFFSET:9.83

OFFSET:7.08

17.72TOP


17.79P E:6338550.567 E:6338579.950 OFFSET:22.7 17.56P 15.45TOE 79LF **9** \$=0.0013 15.65TOE 15.45TOE 15.55TOE/ <u> 16.19T0E</u> 16.87FG/ MATCH EX UPRR R/W STA:37+65.22 OFFSET:36.66 ○H 17.27P○H ○H ── END CONSTRUCTION STA:39+19.74 7.90(R) OH 17.91 FL OH OH INSTALL CALTRANS STANDARD FLARED END— SECTION AT INVERT = 15.55, WITH TYPE I OR III CONNECTION PER CALTRANS STANDARD INSTALL CALTRANS STANDARD FLARED END—
SECTION AT INVERT = 15.50, WITH TYPE I OR
III CONNECTION PER CALTRANS STANDARD
SPECIFICATIONS SECTION 70 AND DRAWING
D94A. INSTALL RIP RAP AT OUTLET TO
PROTECT AGAINST SEDIMENT BUILDUP **LEGEND** GRAVEL SHOULDER
CLASS II AGGREGATE BASE COMPACTED TO 95%;
2' MINIMUM WIDTH, 6" DEEP SPECIFICATIONS SECTION 70 AND DRAWING D94A. INSTALL RIP RAP AT OUTLET TO PROTECT AGAINST SEDIMENT BUILDUP AC PAVEMENT SEE DETAIL 3 AND 9 ON SHEET ROO4 INSTALL 4,000 PSI CONCRETE — FROM FINISH GRADE TO TOP OF 12" C.M.P. PIPE. STAMPED AND COLORED CONCRETE MEDIAN FILL SEE DETAIL 4 ON SHEET ROO4 DRAWN BY:


MDE
CHECKED BY:


UNION PACIFIC
RAILROAD BENCHMARK: CITY OF STOCKTON BENCHMARK NO. 119 Office of Assistant Vice President EXISTING CONCRETE AT RAILROAD TRACKS EXISTING CONCRETE TO BE UNDISTURBED **Engineering Design/Construction** UNLESS OTHERWISE NOTED BRASS DISK MARKING C.O.S. MONUMENT STAMPED "3S-2" IN MONUMENT WELL ON PJS LOCATION & DESCRIPTION: SCALE: 1"=20' THE WEST SIDE OF MCKINLEY AVENUE AT THE APPROXIMATE CENTERLINE OF Stockton, California
Oakland Subdivision MP 90.37 INDUSTRIAL DRIVE, EAST OF THE WESTERN PACIFIC R.R. R/W, EXTENDED WESTERLY. 07/12/2016 SIEGFRIED Industrial Drive/McKinley Avenue and UPRR Crossing Safety Improvements ELEVATION = 20.50SHEET NUMBER PLAN AND PROFILE MCKINLEY AVE. DATE SIGNED: 07/12/16 3244 Brookside Road, Suite 100 Stockton, California 95219

DATUM = NAVD 88 (2008 REVISION, CITY OF STOCKTON)

R002

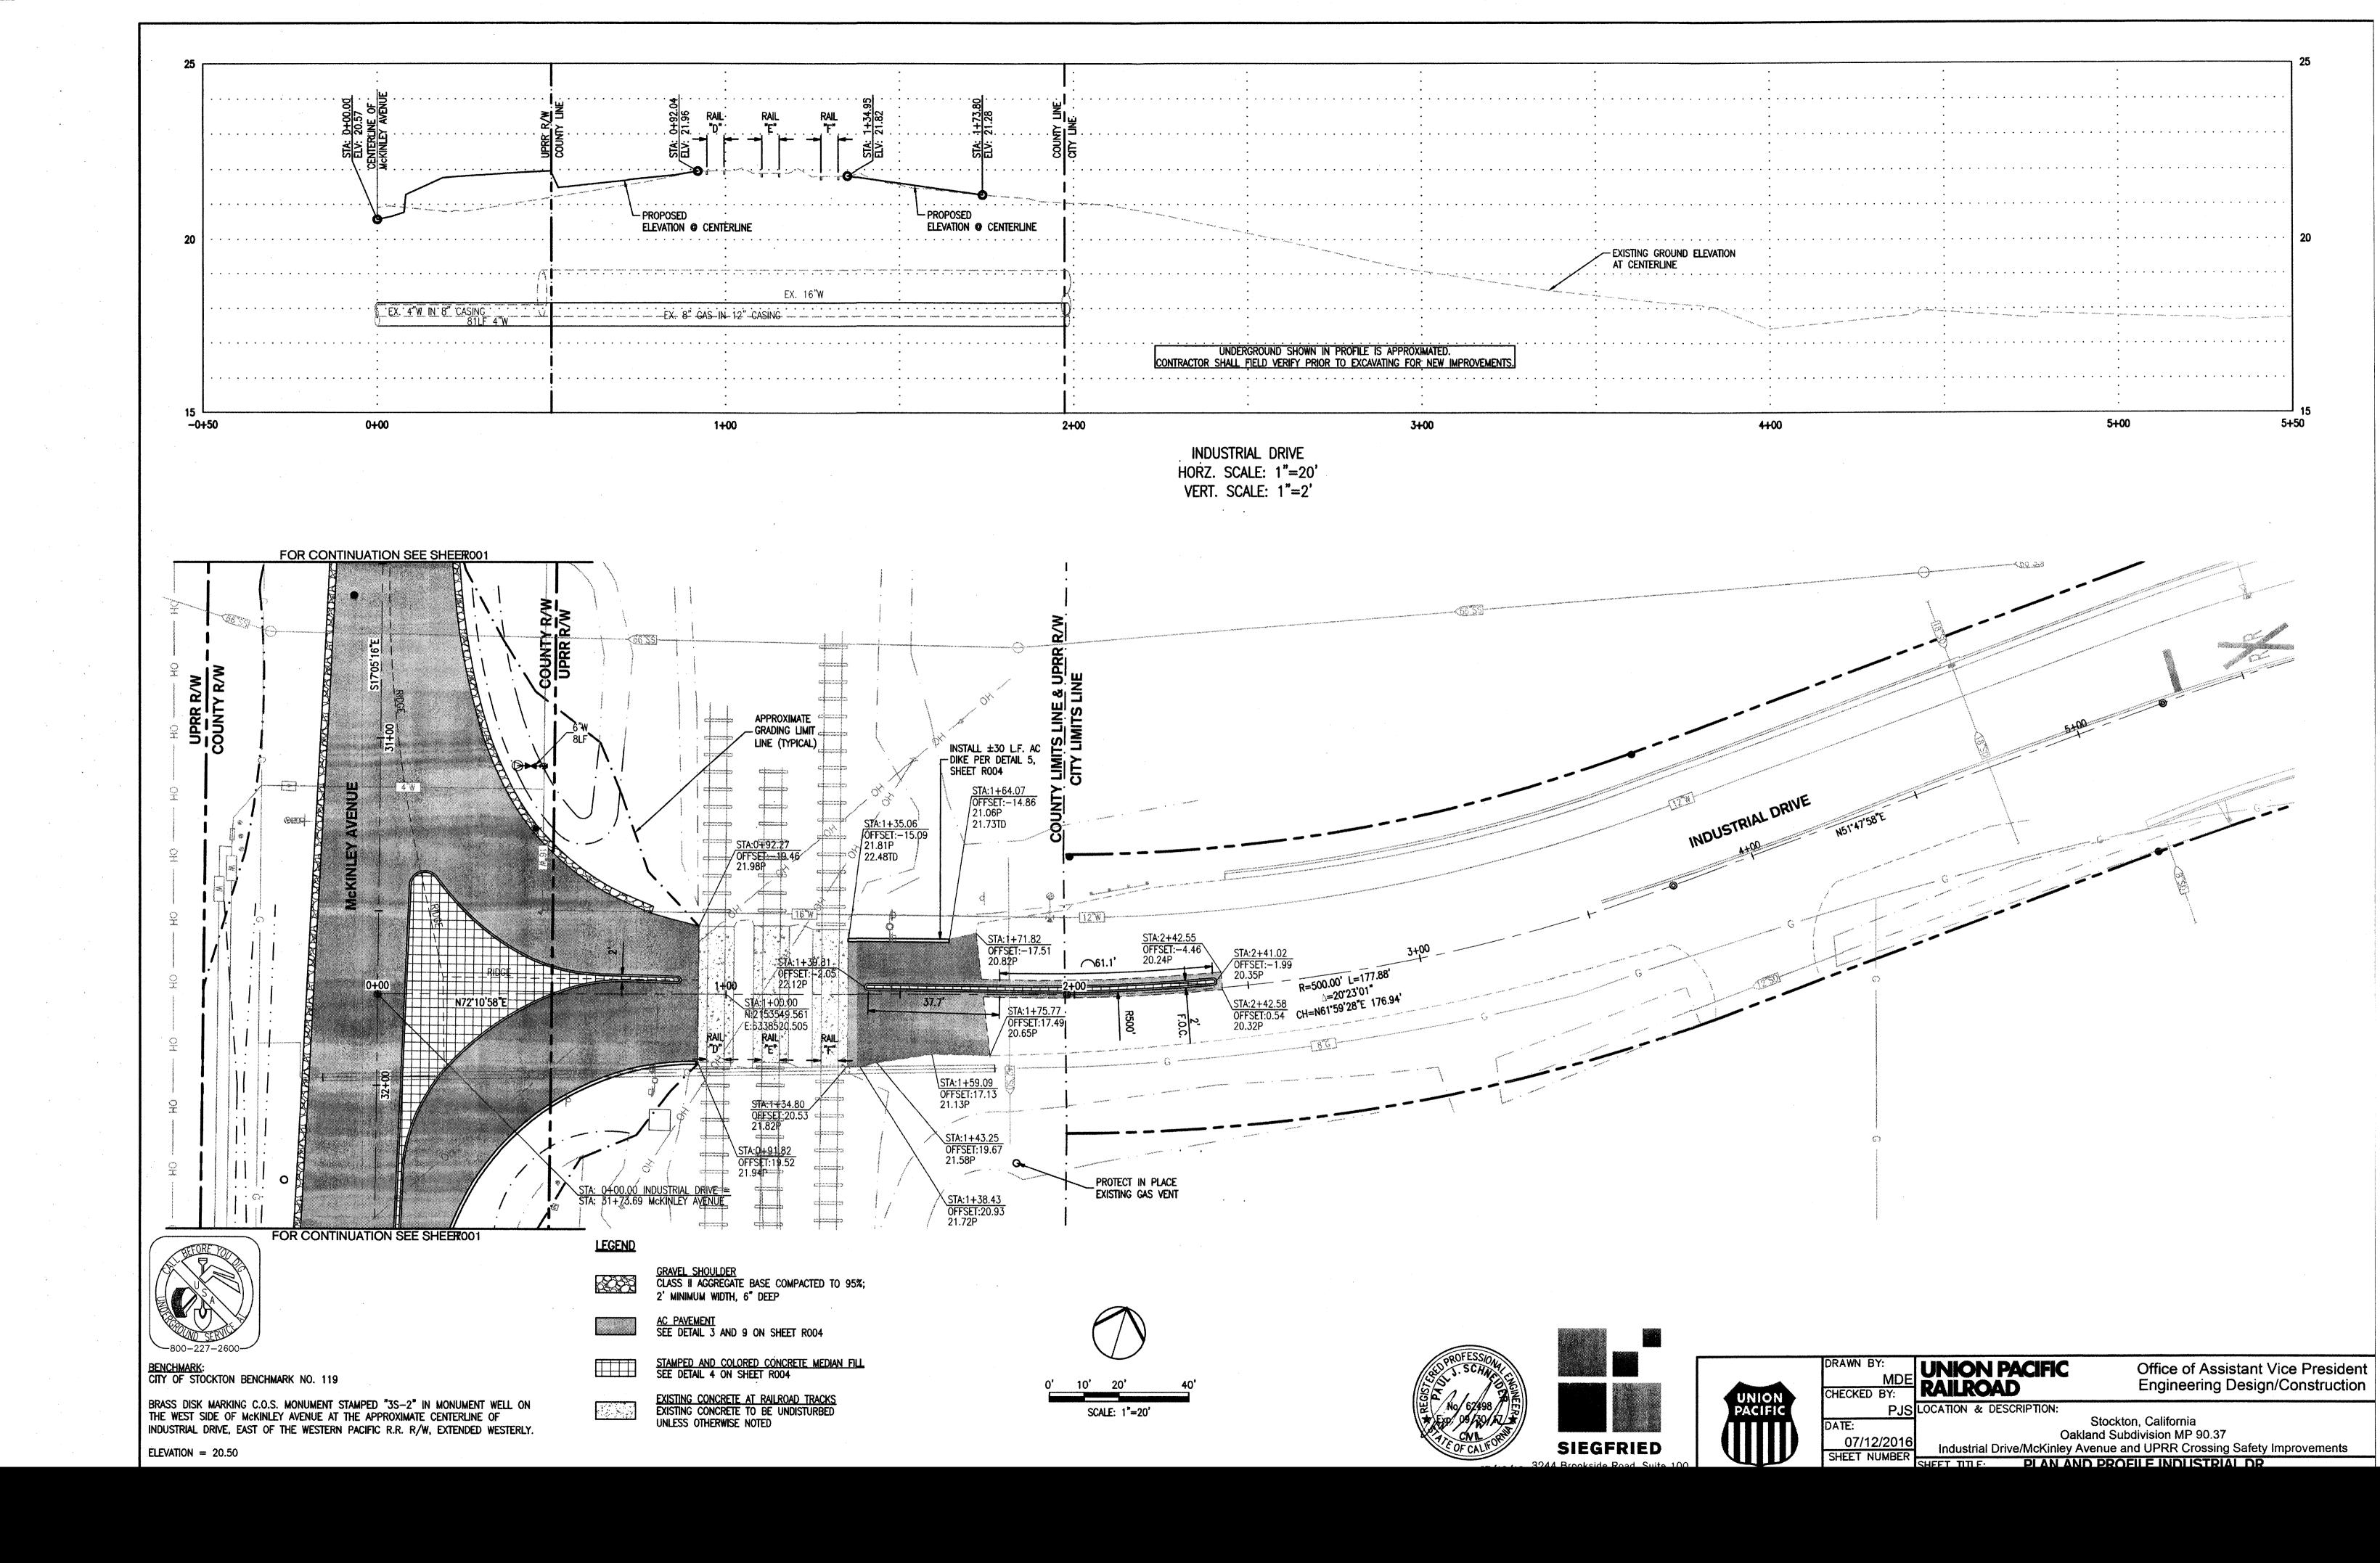

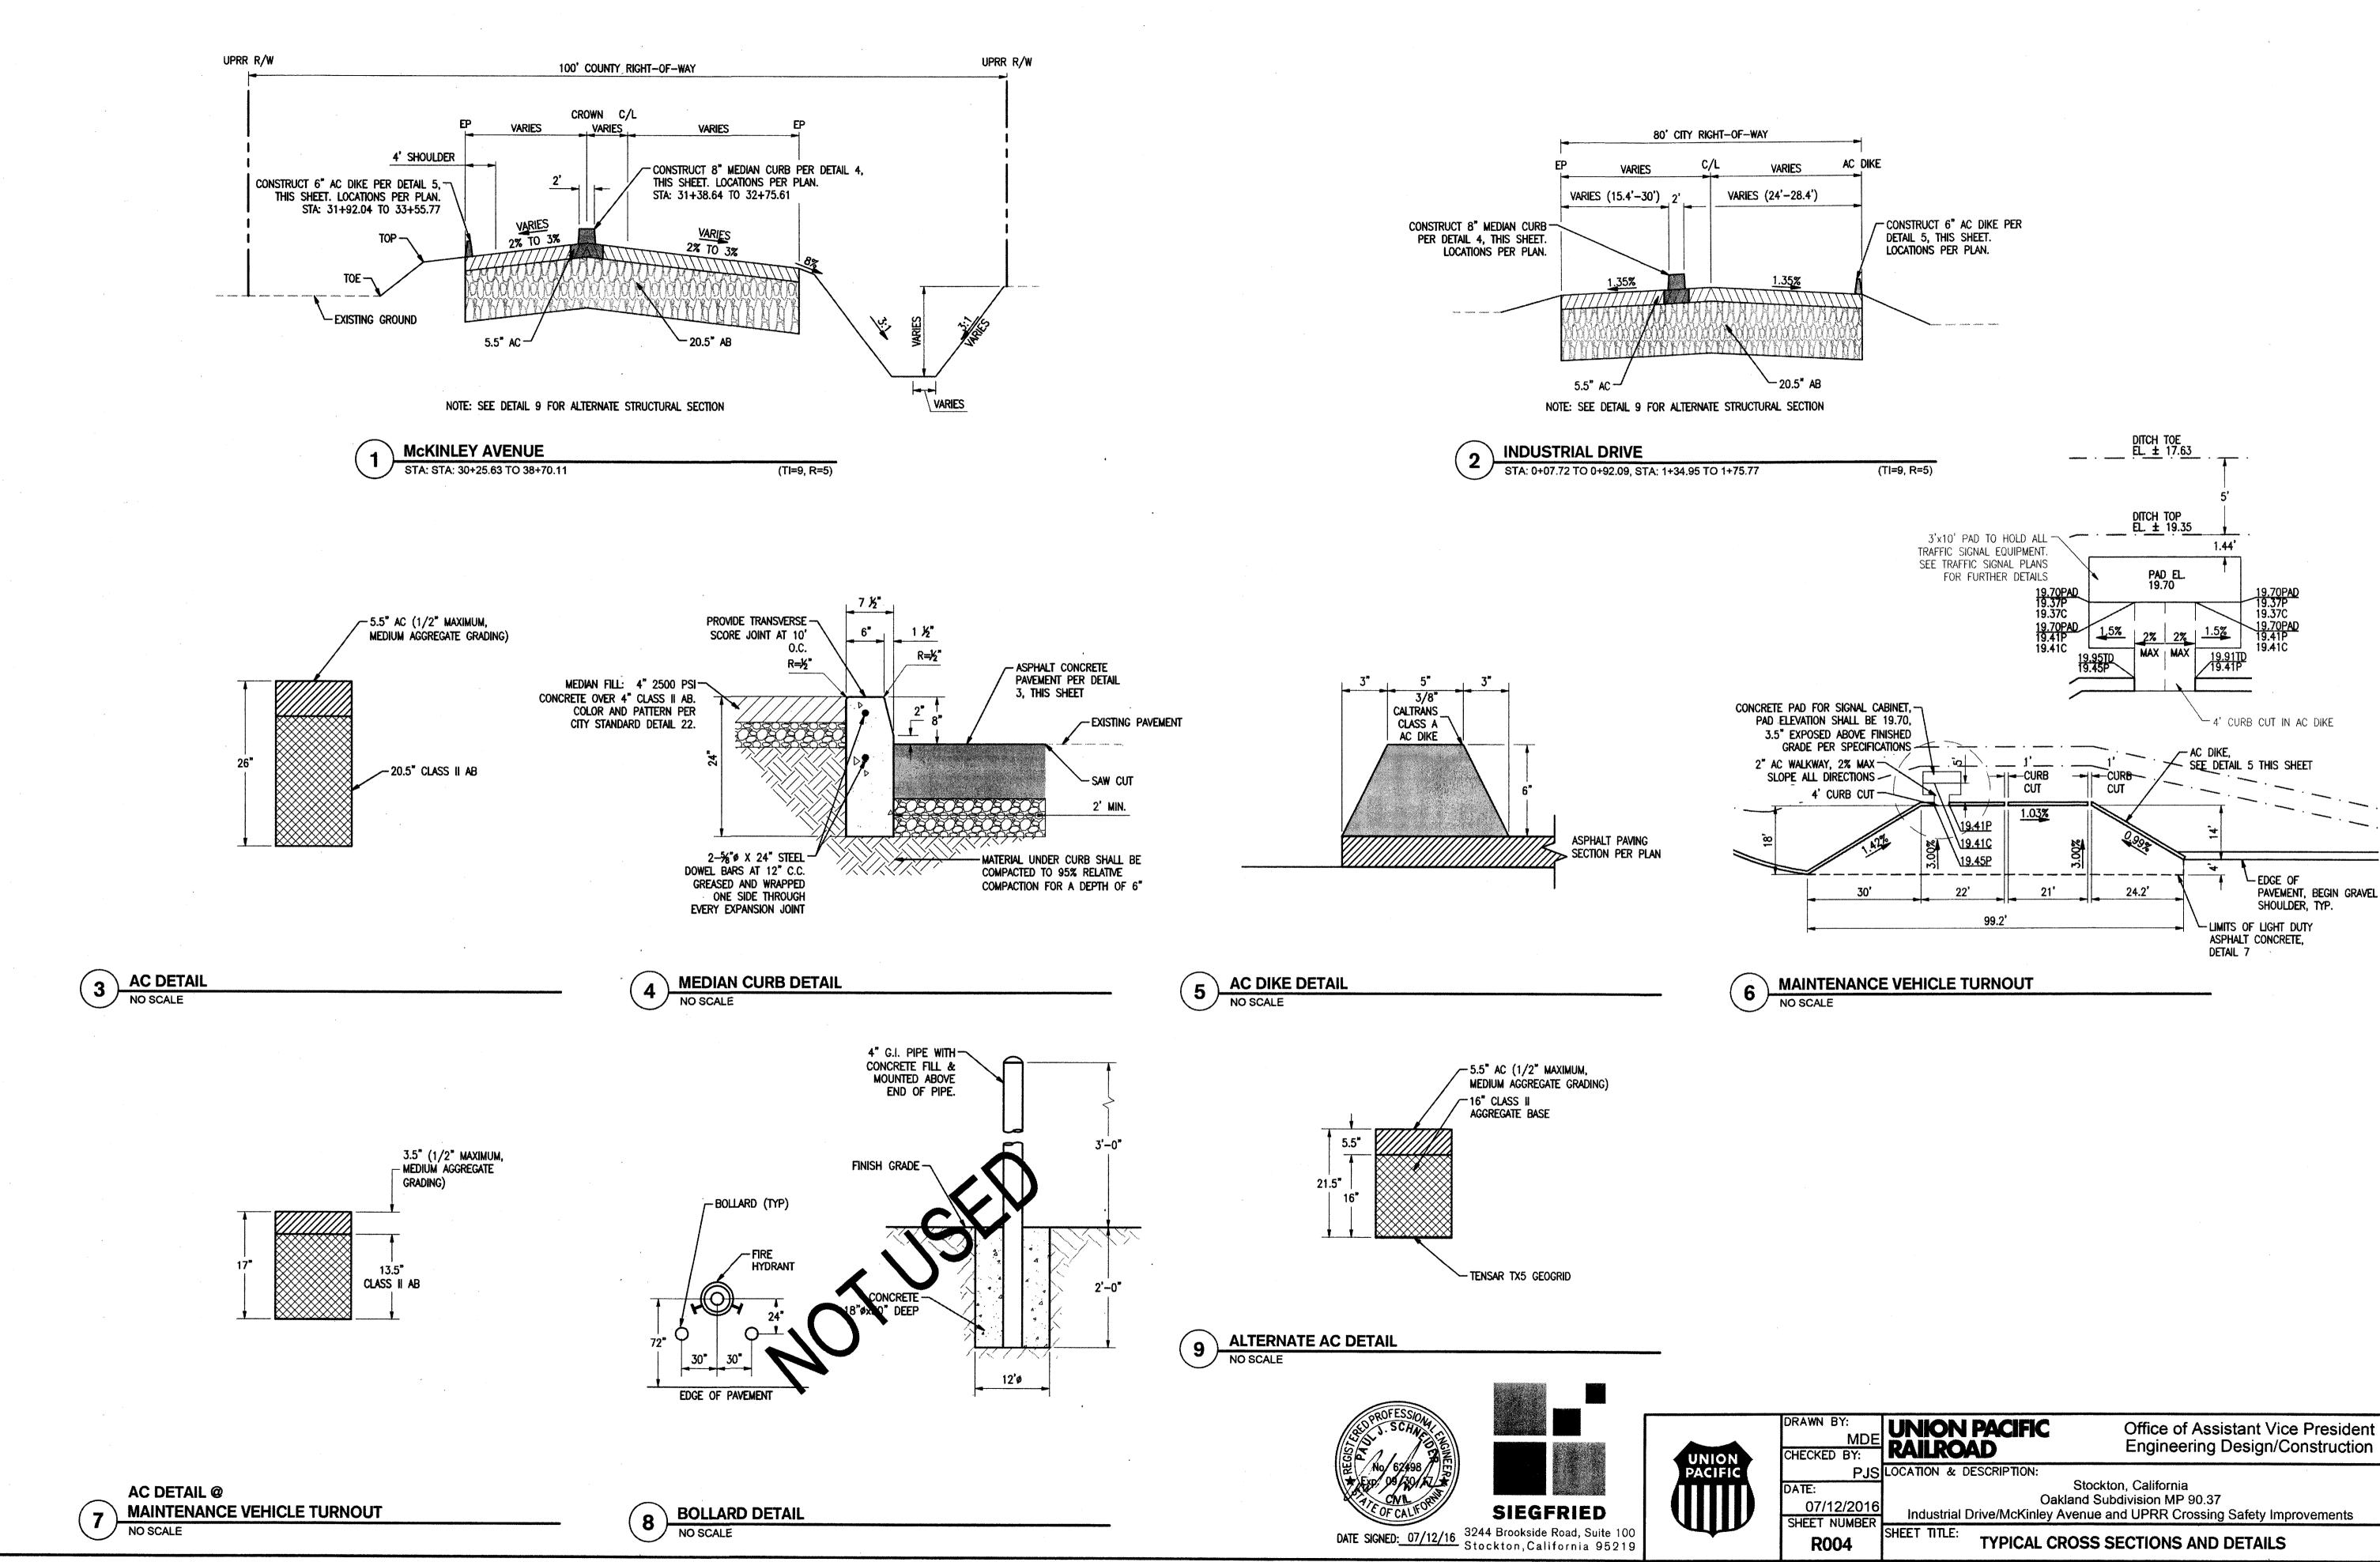

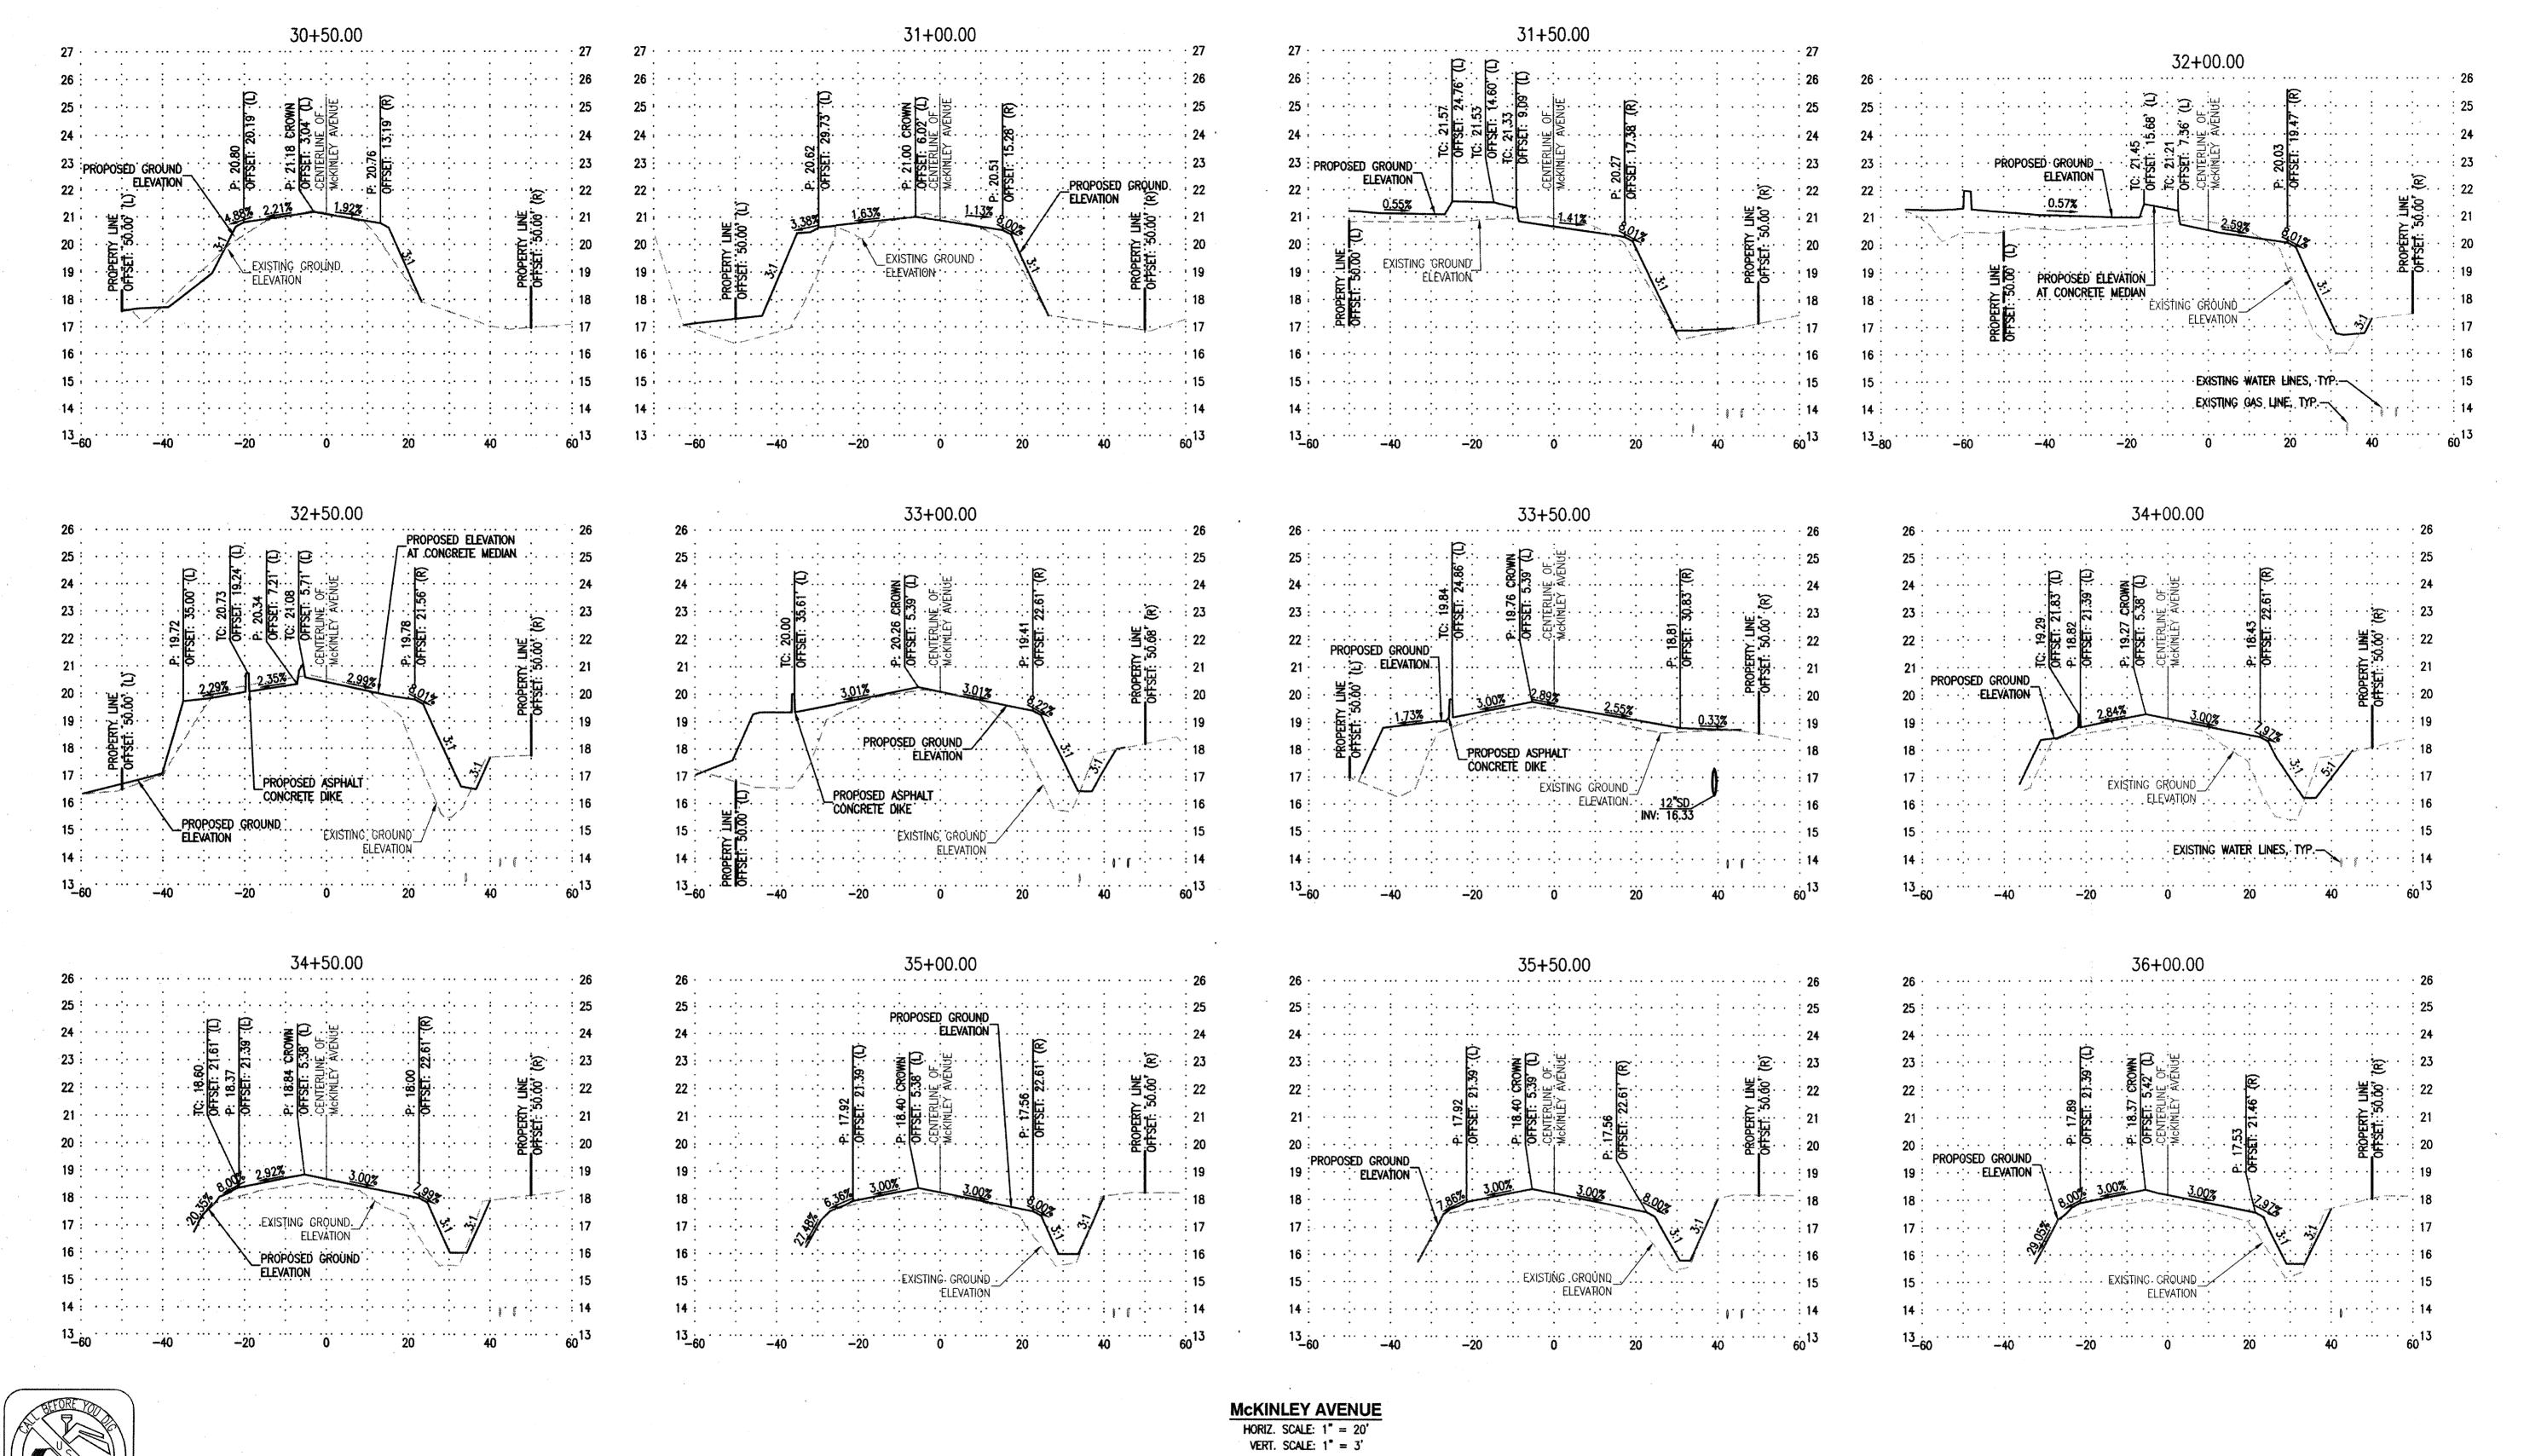





BENCHMARK: CITY OF STOCKTON BENCHMARK NO. 119


BRASS DISK MARKING C.O.S. MONUMENT STAMPED "3S-2" IN MONUMENT WELL ON THE WEST SIDE OF MCKINLEY AVENUE AT THE APPROXIMATE CENTERLINE OF INDUSTRIAL DRIVE, EAST OF THE WESTERN PACIFIC R.R. R/W, EXTENDED WESTERLY.

ELEVATION = 20.50

DATUM = NAVD 88 (2008 REVISION, CITY OF STOCKTON)

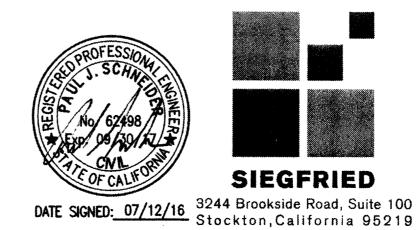

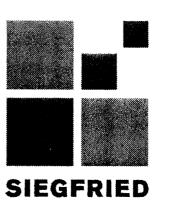

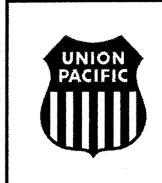

ATE:

07/12/2016

SHEET NUMBER


UNION PACIFIC CHECKED BY: RAILROAD


Office of Assistant Vice President **Engineering Design/Construction**

PJS LOCATION & DESCRIPTION:

Stockton, California Oakland Subdivision MP 90.37 Industrial Drive/McKinley Avenue and UPRR Crossing Safety Improvements

SHEET TITLE: **SECTIONS**

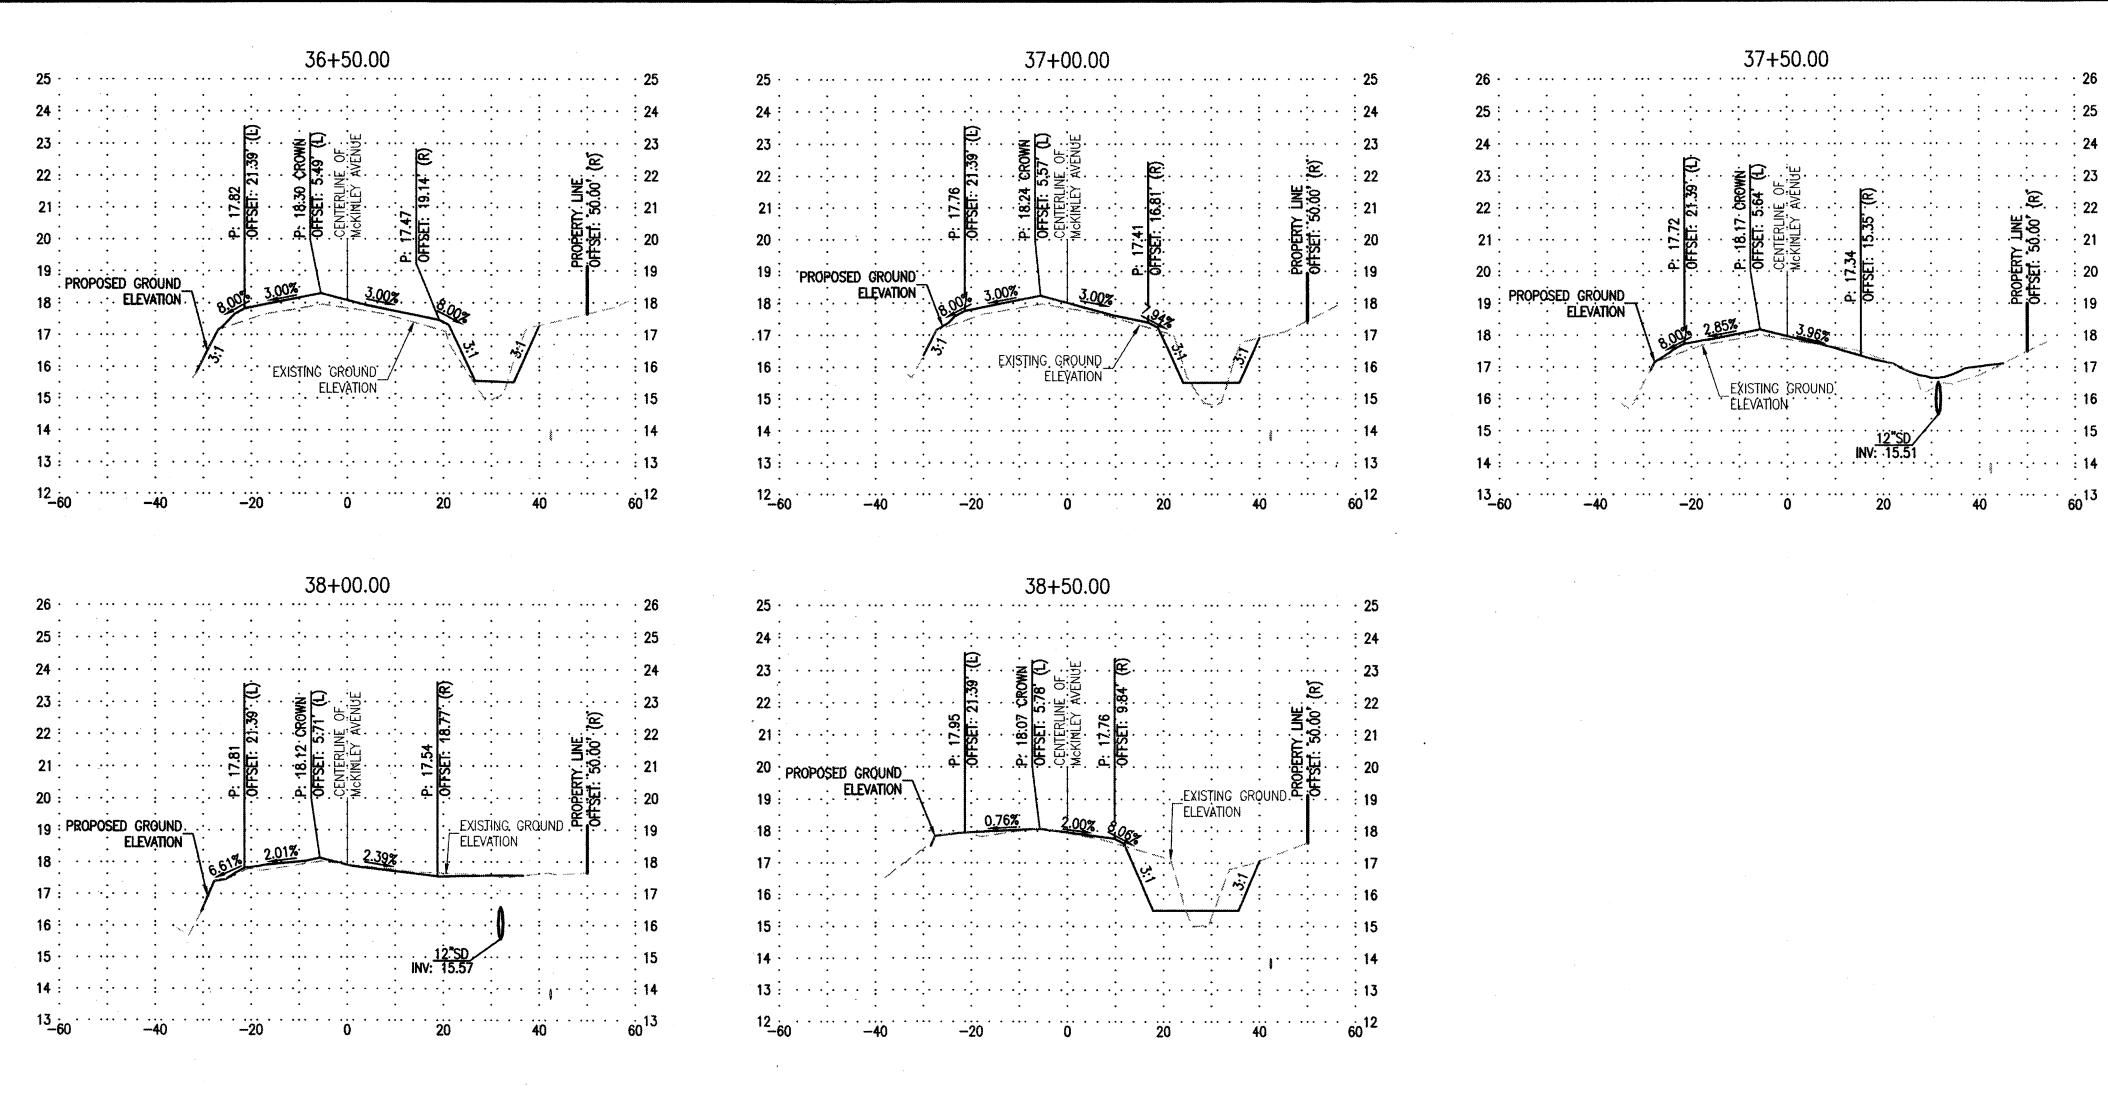

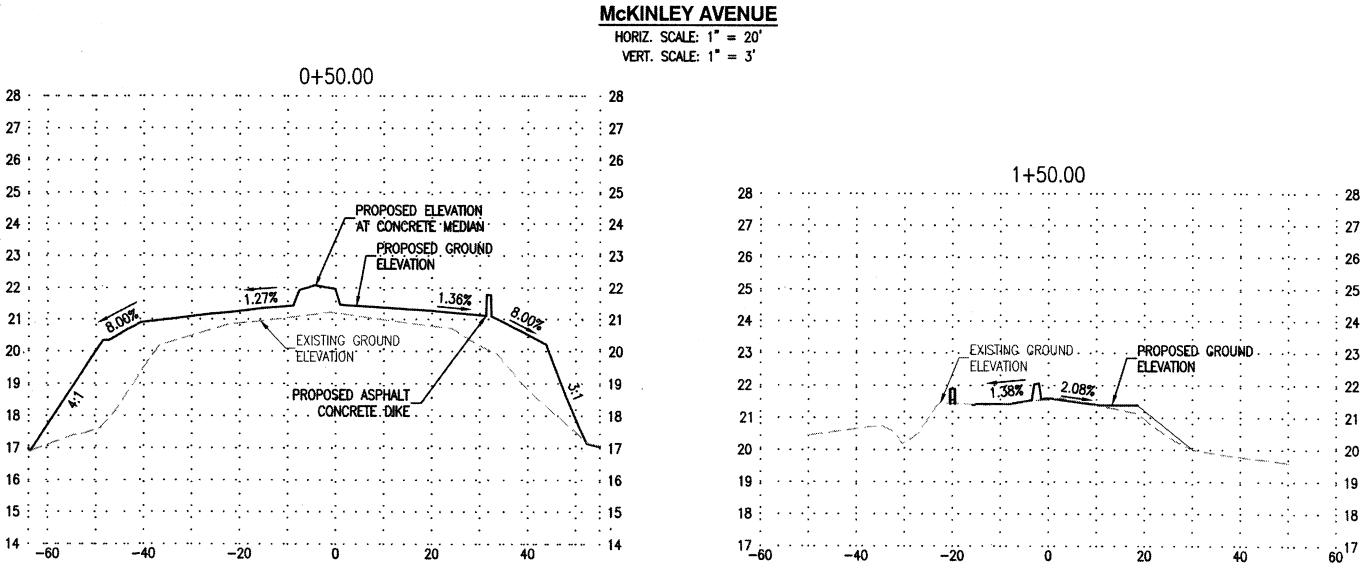



BENCHMARK: CITY OF STOCKTON BENCHMARK NO. 119


BRASS DISK MARKING C.O.S. MONUMENT STAMPED "3S-2" IN MONUMENT WELL ON THE WEST SIDE OF MCKINLEY AVENUE AT THE APPROXIMATE CENTERLINE OF INDUSTRIAL DRIVE, EAST OF THE WESTERN PACIFIC R.R. R/W, EXTENDED WESTERLY.

ELEVATION = 20.50

DATUM = NAVD 88 (2008 REVISION, CITY OF STOCKTON)



VERT. SCALE: 1'' = 3'

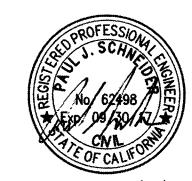



RAILROAD CHECKED BY:

07/12/2016

SHEET NUMBER

X002

UNION PACIFIC

Office of Assistant Vice President **Engineering Design/Construction**

PJS LOCATION & DESCRIPTION: Stockton, California Oakland Subdivision MP 90.37

CUT & FILL VOLUMES

VOLUME

(CY)

2.35

9.70

13.74

10.70

0.98

13.98

4.04

2.35

5.56

8.06

13.13

1.87

6.57

1. THE NUMBER OF 818.75 CY FILL IS EXISTING GROUND TO FINISH GROUND VOLUMES ONLY. AND DOES

2. EXISTING ROADWAY STRUCTURAL SECTION IS 929.4 CY. (AN ADDITIONAL EXCAVATION OF 1,372 CY. IS

5. CUT AND FILL WILL BE DEPENDENT UPON THE STRUCTURAL SECTION SELECTED BY THE CONTRACTOR.

NET VOLUME IS +818.75 CY FILL -1,372 CY CUT -820 CY CUT =1,373.25 CY CUT.

AN ADDITIONAL 820 CY CUT IS REQUIRED FOR WIDENING MCKINLEY AVENUE (IF 26" SECTION SELECTED)

VOLUME

(CY)

11.35

104.50

48.06

111.87

83.72

168.15

92.41

81.28

55.15

27.30

42.26

42.91

32.35

22.63

17.52

4.57

3.88

CUMULATIVE

VOLUME

5.88

108.03

146.38

247.55

317.53

474.97

566.40

633.69

709.97

749.88

787.23

811.53

821.03

836.68

834.68

818.75

FILL AREA

(Sq. Ft)

12.26

56.43

25.95

60.41

45.21

90.80

49.90

43.89

29.78

14.74

22.82

23.17

17.47

12.22

9.46

2.47

CUT AREA

(Sq. Ft)

5.91

1.27

5.24

5.78

7.42

5.78

0.53

7.55

2.18

1.15

1.27

3.00

4.35

7.09

1.01

3.55

NOT INCLUDE CUT FOR ROADWAY STRUCTURAL SECTION.

REQUIRED IF 26" STRUCTURAL SECTION IS SELECTED).

STA.

30+50.00

31+00.00

31+50.00

32+00.00

32+50.00

33+00.00

33+50.00

34+00.00

34+50.00

35+00.00

35+50.00

36+00.00

36+50.00

37+00.00

37+50.00

38+00.00

38+50.00

Industrial Drive/McKinley Avenue and UPRR Crossing Safety Improvements SHEET TITLE: **SECTIONS II**

5261.11C

GENERAL NOTES

- 1. THESE PLANS ARE HEREBY MADE PART OF THE CONTRACT SPECIFICATIONS FOR THIS PROJECT.
- 2. ALL WORK AND MATERIAL EMBRACED IN THIS PROJECT SHALL BE DONE IN ACCORDANCE WITH APPLICABLE PROVISIONS OF THE SAN JOAQUIN COUNTY, THE CITY OF STOCKTON, DEPT. OF PUBLIC WORKS, STANDARD SPECIFICATIONS AND PLANS, THE LATEST EDITIONS OF CALTRANS STANDARD PLANS AND SPECIFICATIONS, THE LATEST EDITION OF THE CALIFORNIA MANUAL OF UNIFORM TRAFFIC CONTROL DEVICES, AND IN ACCORDANCE WITH THE SPECIAL PROVISIONS OF THIS PROJECT.
- 3. ADDITIONAL NOTES CAN BE FOUND ON SHEET GOO2. GENERAL NOTES AND SPECIFICATIONS.
- 4. POLES, PULL BOXES, DETECTOR HAND HOLES, INDUCTIVE LOOPS AND CONTROLLER CABINET LOCATIONS SHALL BE LOCATED IN THE FIELD BY THE ENGINEER WITH THE APPROVAL OF THE CITY TRAFFIC ENGINEER. TYPICALLY, DETECTOR HAND HOLES SHOULD BE INSTALLED ON LANE LINES.
- 5. CONTRACTOR SHALL RETURN EXISTING & SALVAGEABLE EQUIPMENT AND SIGNS IN CITY RIGHT OF WAY TO THE CITY OF STOCKTON CORPORATION YARD AT 1465 SOUTH LINCOLN STREET, STOCKTON, CALIFORNIA, 95206. CONTRACTOR SHALL NOTIFY CITY'S OPERATION AND MAINTENANCE AT (209)-937-8341 A MINIMUM OF 3 WORKING DAYS IN ADVANCE OF DELIVERY.
- 5. CONTRACTOR SHALL RETURN EXISTING & SALVAGEABLE EQUIPMENT AND SIGNS IN COUNTY RIGHT OF WAY TO THE SAN JOAQUIN COUNTY MAINTENANCE YARD ON 1810 E HAZELTON AVENUE, STOCKTON, CALIFORNIA, 95205. CONTRACTOR SHALL NOTIFY COUNTY'S MAINTENANCE AT (209)-468-3000 A MINIMUM OF 3 WORKING DAYS IN ADVANCE OF DELIVERY.
- 6. CONTRACTOR SHALL BACKFILL WITH CUTBACK EACH NIGHT ANY AREAS NOT COMPLETED TO IT'S FINISHED STATE. ALL EXCAVATED AREAS SHALL BE PROTECTED FROM PEDESTRIAN AND VEHICULAR TRAFFIC AT ALL TIMES.
- 7. ALL PULL BOXES SHALL BE STATE STANDARD NUMBER 5 UNLESS OTHERWISE NOTED ON PLAN.
- 8. THE CONTRACTOR SHALL BE RESPONSIBLE TO NOTIFY P.G.&E. AND OTHER UTILITY COMPANIES (COMCAST, CAL WATER, AT&T, SUNESYS, VERIZON, KINDER MORGAN, SPRINT) PRIOR TO START OF WORK. THE CONTRACTOR SHALL CALL U.S.A. (800-227-2600) 2-WORKING DAYS PRIOR TO ANY EXCAVATION.
- 9. CONDUITS RUNNING FROM PULL BOX TO HAND HOLE AND HAND HOLE TO HAND HOLE SHALL BE A MINIMUM 2" DIA. UNLESS OTHERWISE NOTED.
- 10. FLASHING INDICATIONS SHALL FLASH IN RED ON ALL PHASES.
- 11. CONTRACTOR SHALL, BY HAND, POTHOLE EXISTING UTILITIES TO VERIFY LOCATION PRIOR TO CONSTRUCTION.
- 12. CONDUIT ROUTING SHOWN IS ESSENTIALLY DIAGRAMMATIC. CONTRACTOR SHALL LAYOUT RUNS TO SUIT FIELD CONDITIONS AND THE COORDINATION REQUIREMENTS OF UTILITIES OR ANY OTHER TRADES. AND TO THE SATISFACTION OF THE CITY OF STOCKTON. UPON COMPLETION OF CONDUIT INSTALLATION. THE ACTUAL LOCATION OF THE CONDUITS SHALL BE NOTED ON AN AS-BUILT SET OF PRINTS AND FURNISHED TO THE CITY.
- 13. ALL VEHICLE INDICATIONS SHALL BE 12 INCH. ALL SIGNAL HEADS SHALL HAVE VENTILATED BACK PLATES.
- 14. THE CONTRACTOR SHALL NOTIFY CITY OF STOCKTON OPERATION AND MAINTENANCE AT (209)—937—8341 A MINIMUM OF 3 WORKING DAYS IN ADVANCE OF THE LAY OUT AND CUTTING OF TRAFFIC SIGNAL LOOPS.
- 15. THE CONTRACTOR SHALL MARK LOOP LOCATIONS, LOOP WIRE RUNS AND DETECTOR HAND HOLES AND HAVE LOCATIONS APPROVED BY THE ENGINEER PRIOR TO INSTALLATION.
- 16. ALL EVP DETECTORS SHALL BE INSTALLED AS SHOWN ON PLAN. SEE EVP MOUNTING DETAIL ON SHEET CD-1.
- 17. CONTRACTOR TO REPLACE ALL DAMAGED ITEMS DURING CONSTRUCTION.





05/06/2016 SHEET NUMBER GN-1

UNION PACIFIC RAILROAD

Office of Assistant Vice President Engineering Design/Construction

Stockton, California Oakland Subdivision MP 90.37 Industrial Drive/McKinley Avenue and UPRR Crossing Safety Improvements

TRAFFIC SIGNAL NOTES

5261.126

LEGEND


THE PLAN SHEET.


SEE CALTRANS STANDARD PLANS A10C, ES-1A, AND ES-1B FOR SYMBOLS AND

ABBREVIATIONS. ALL SYMBOLS ARE STANDARD CALTRANS SYMBOLS, UNLESS NOTED ON

DRAWN BY:
AH
CHECKED BY:

LOCATION & DESCRIPTION:

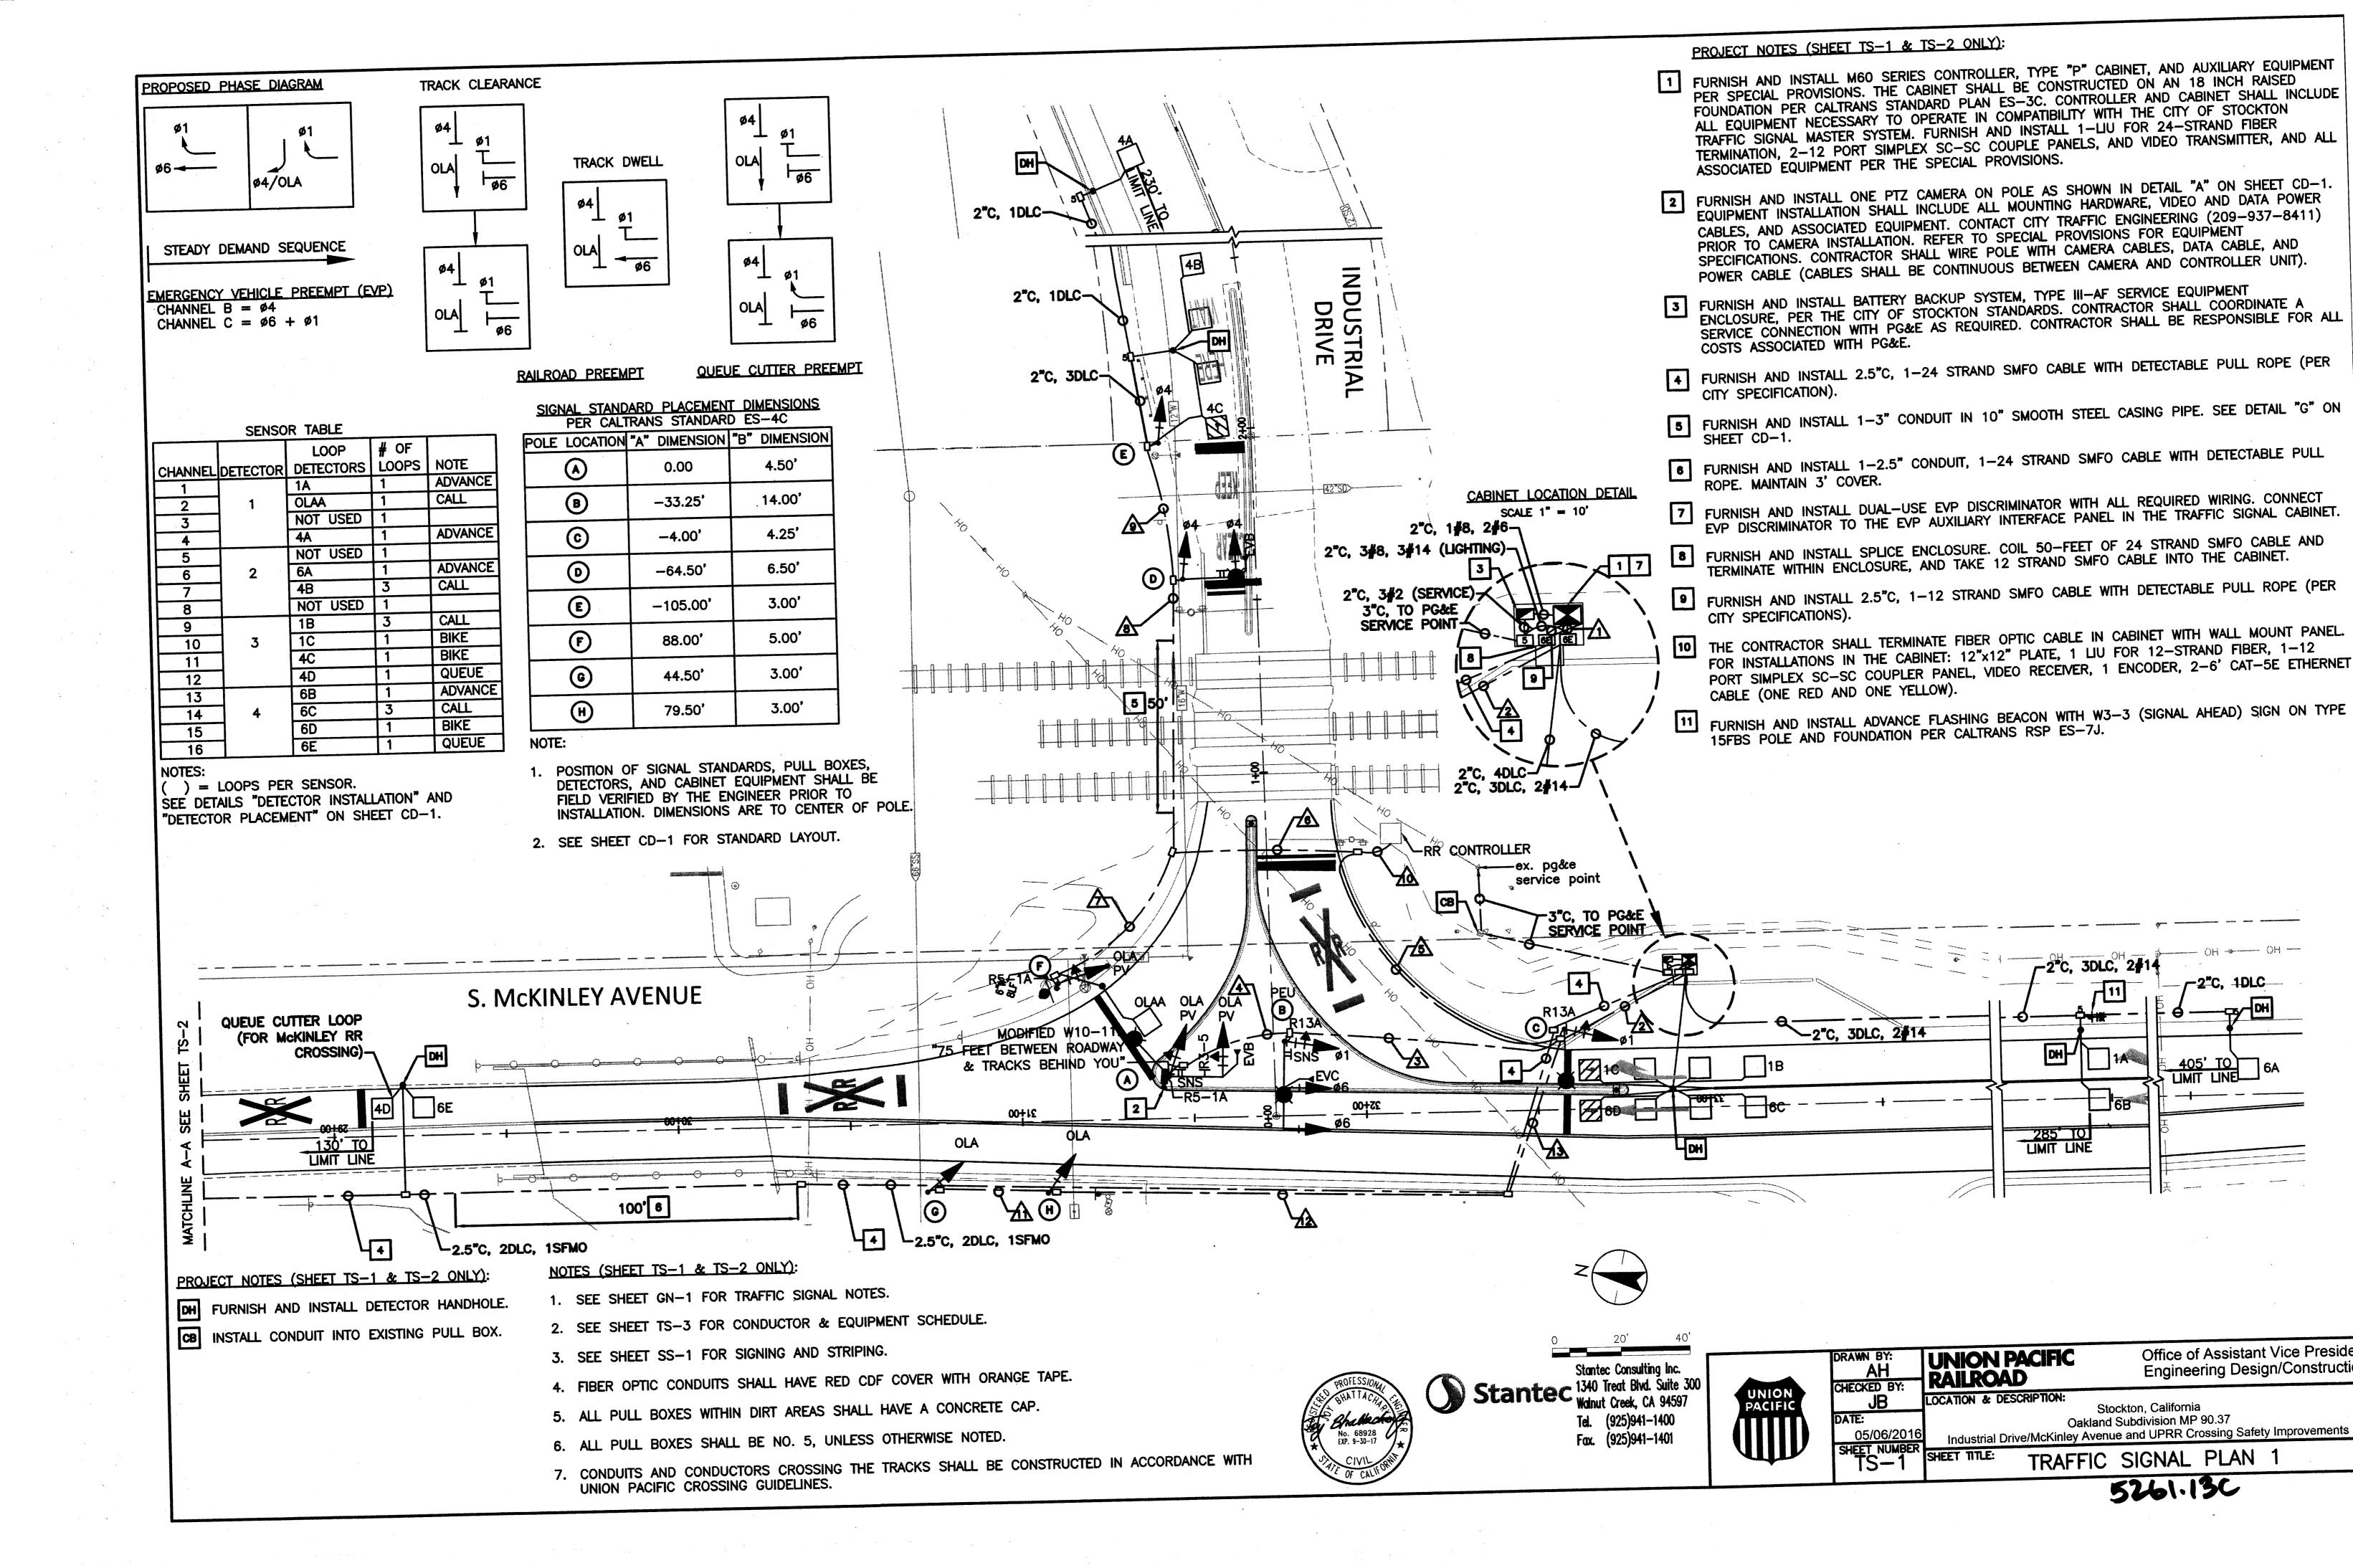

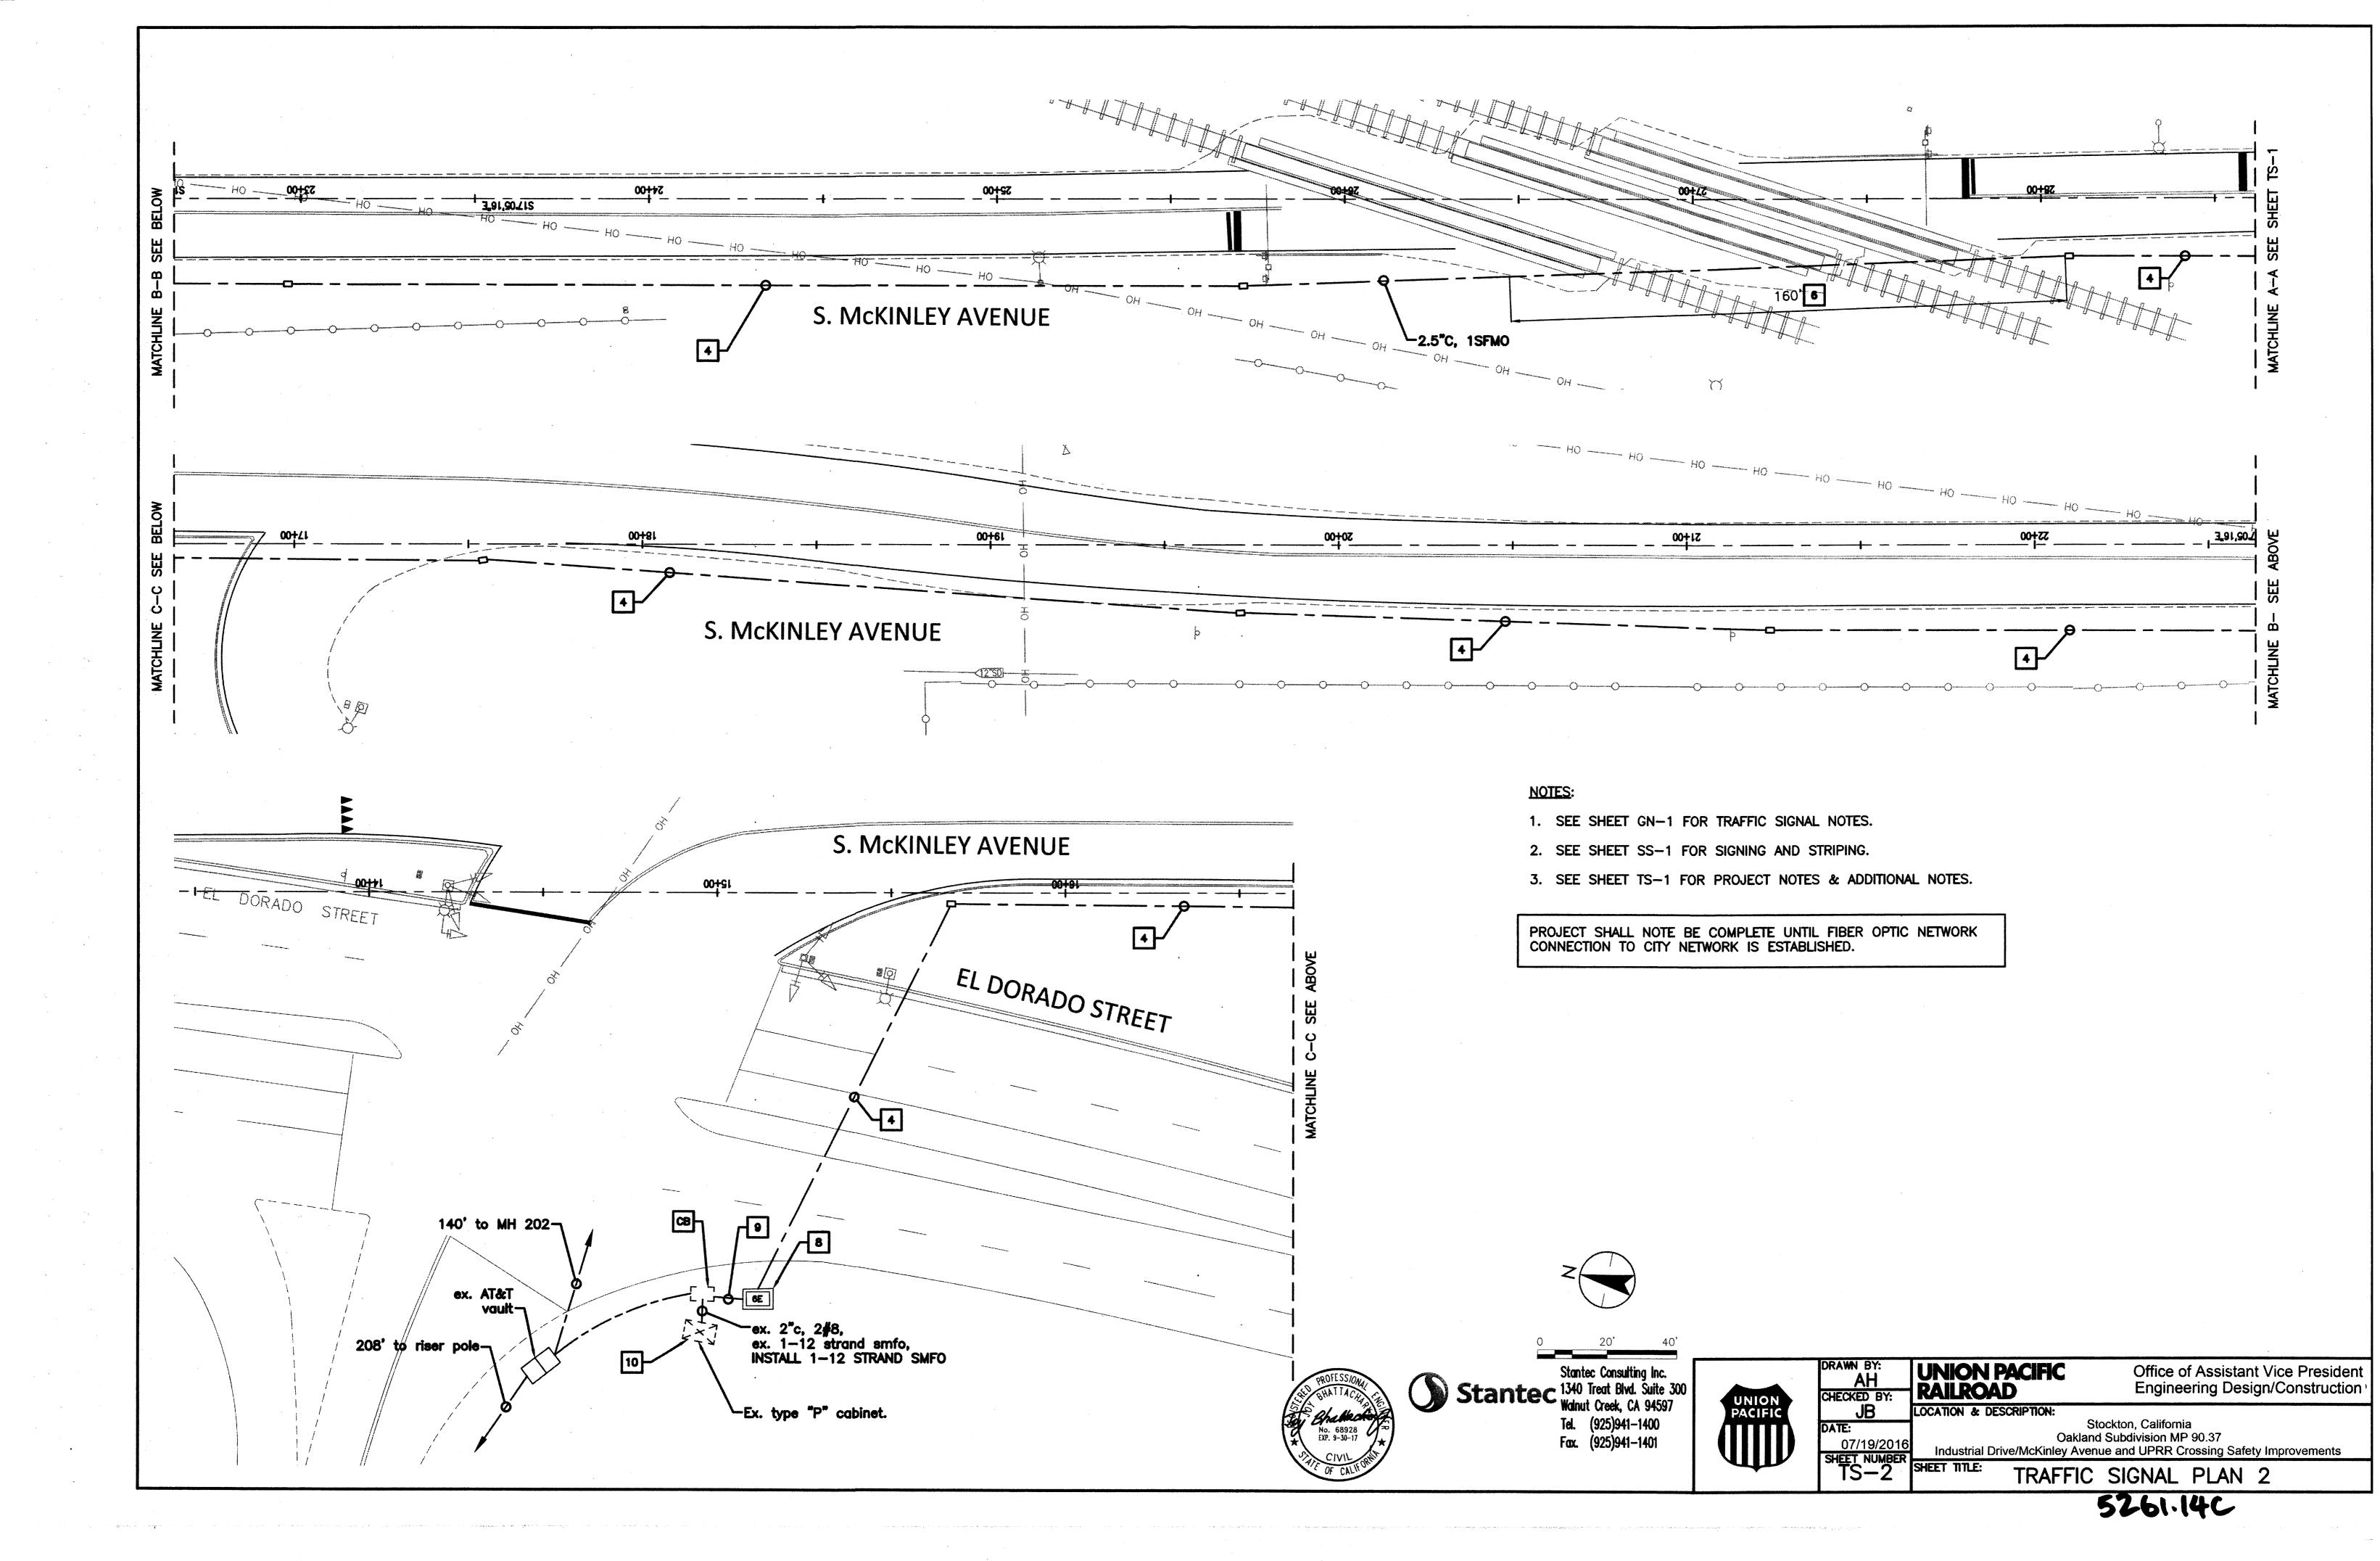

. I					DUCTOR	170FE	DIBIO		<u> </u>	· · · · · · · · · · · · · · · · · · ·				
AWG	CIRCUIT		٨	Δ		Δ	RUNS		A	A	Δ	Λ	Δ	
	41 CICNAI	3	3	3	A	<u>\$</u>	<u>6</u>	A	<u>8</u>		10	W	12	1
	ø1 SIGNAL ø4 SIGNAL	3	3			3	3		3	3				_
	ø6 SIGNAL	3	3	3		Y								
	ØOLA SIGNAL	6	6	3	3	3	3	3				3	3	
	POLICIONE	 			i									
	PEU		3	3										
No. 14	SPARE	6	6	3	3	6	6	3	3	3		3	3	
110. 17	FLASHING BEACON	2			·		-							
	PEASITING BEACON													
							·						·	
				·										
	TOTAL No.14	23	24	12	6	12	12	6	6	6		6	6	
	SIGNAL COMMON	1	1	1	: 1	1	1		1					_
No. 8	LUMINAIRE		2	2	2	2	2		2				·	
	TOTAL No.8		3	3	3	3	3		3					
	SIGNAL	 												
No. 6														
No. 2	SERVICE					. ,								
	Ø1	3												
DLC	ø4	4	4			3	3		3	3	,			
	ø6	5	1			3	3		3					
	OLA	1	1			1	1	1						
	TOTAL 010	47				-,				-				-
	TOTAL DLC	13	6			7	7		6	3				
	EVB	1	1	1	1	1	1	1	1					
EVP	EVC	1	1	1	 '	 	•	 ' -	 ' -	<u> </u>	 		<u> </u>	+
		+ -		<u> </u>										\vdash
	TOTAL CABLES	2	2	2	1	1	1	1	1					
	POWER	1	1	1					·					_
ссту	VIDEO/DATA	1	1	1							·			
	TOTAL CARLES													
	TOTAL CABLES	2	2	2				·	·					
	12-#14 CABLE	1	1			1					1			
RR CONTROL														
	MATTER MATERIAL STATE OF THE ST													
COND	JIT SIZE (INCHES)	2-4"	3"	3"	3"	3"	3"	3"	3"	3"	3"	3"	3"	
	CONDUIT FILL	%	%	%	%	%	%	%	%	<i>%</i>	%	 	 	 '

ALL	CONDUCTORS	ARE	NEW	UNLESS	OTHERWISE	NOTED.	

	EQUIPMENT SCHEDULE												
	POLE		MAST	ARM	LUMINAIRE			SNAL MOUNT	ING		REMARKS		
LOC	TYPE	HGT	SIG	LUM	LOMINAINE	PHASE	SECTION	VEHICLE	PED	PPB	NEMARKS		
	19-4-100	30'	15'	15'	87W LED	ØOLA	12 " A	MAS			FURNISH AND INSTALL EVP AT THE END OF THE MAST ARM. SEE DETAIL ON SHEET CD-1.		
				.0		ØOLA	12 " A	SV-1-T			LUMINAIRE MAST ARM SKEW 135°. FURNISH AND INSTALL PTZ CAMERA ON LUMINAIRE MAST ARM. SEE DETAIL ON SHEET CD-1.		
											FURNISH AND INSTALL STREET NAME SIGN (SNS) AND R3-5 SIGN ON SIGNAL MAST ARM. FURNISH AND INSTALL R5-1A SIGN ON SIGNAL POLE.		
					·						FURNISH AND INSTALL MODIFIED W10-11 "75 FEET BETWEEN ROADWAY & TRACKS BEHIND		
											YOU" SIGN ON SIGNAL POLE		
		·				ø6	12 " A	MAS			FURNISH AND INSTALL EVP BELOW VEHICLE SIGNAL HEAD. SEE DETAIL ON SHEET CD-1.		
B	19-4-100	30'	25'	15'	87W LED	ø6 ø1	12 " 12 " A	MAS SV-1-T			FURNISH AND INSTALL STREET NAME SIGN (SNS) ON SIGNAL MAST ARM. FURNISH AND INSTALL R13A SIGN ON SIGNAL POLE.		
0	TYPE 15TS	70'		15'	87W LED	ø1	12"A	SV-1-T			FURNISH AND INSTALL R13A SIGN ON SIGNAL POLE.		
	111 6 1010	30		13	O/W LLD		127	34-1-1					
0	10 4 100	70'	451	45,	97W 1ED	Ø 4	12"	MAS			FURNISH AND INSTALL EVP AT THE END OF THE MAST ARM. SEE DETAIL ON SHEET CD-1.		
	19-4-100	30	15'	15'	87W LED	ø4	12"	SV-1-T			FURNISH AND INSTALL EVE AT THE END OF THE MAST ARM. SEE DETAIL ON SHEET OD-T.		
E	1-B	10'	·			ø4	12"	TV-1-T					
		ļ											
(F)	1-B	10'				ØOLA	12"A	TV-1-T			FURNISH AND INSTALL R5-1A SIGN ON SIGNAL POLE.		
(6)	1-B	10'				ØOLA	12"A	TV-1-T					
_						<u> </u>							
(H)	1-B	10'				ØOLA	12*A	TV-1-T					
1	1	1		l .		1			1				

⁻ A: INDICATES ALL 12" RIGHT ARROW HEAD

NOTES:

- 1. SEE SHEET GN-1 FOR GENERAL NOTES.
- 2. SEE SHEET TS-1 & TS-2 FOR TRAFFIC SIGNAL PLANS.
- 3. SEE SHEET CD-1 FOR CONSTRUCTION DETAILS.





Stantec Consulting Inc.

Stantec Stantec Consulting Inc.
1340 Treat Blvd. Suite 300
Walnut Creek, CA 94597 Tel. (925)941-1400 Fax. (925)941-1401



DRAWN BY:

AH

CHECKED BY:

JB 05/06/2016 Industrial Display SHEET TITLE:


UNION PACIFIC RAILROAD

LOCATION & DESCRIPTION:

Office of Assistant Vice President Engineering Design/Construction

Stockton, California
Oakland Subdivision MP 90.37
Industrial Drive/McKinley Avenue and UPRR Crossing Safety Improvements

TRAFFIC SIGNAL SCHEDULE

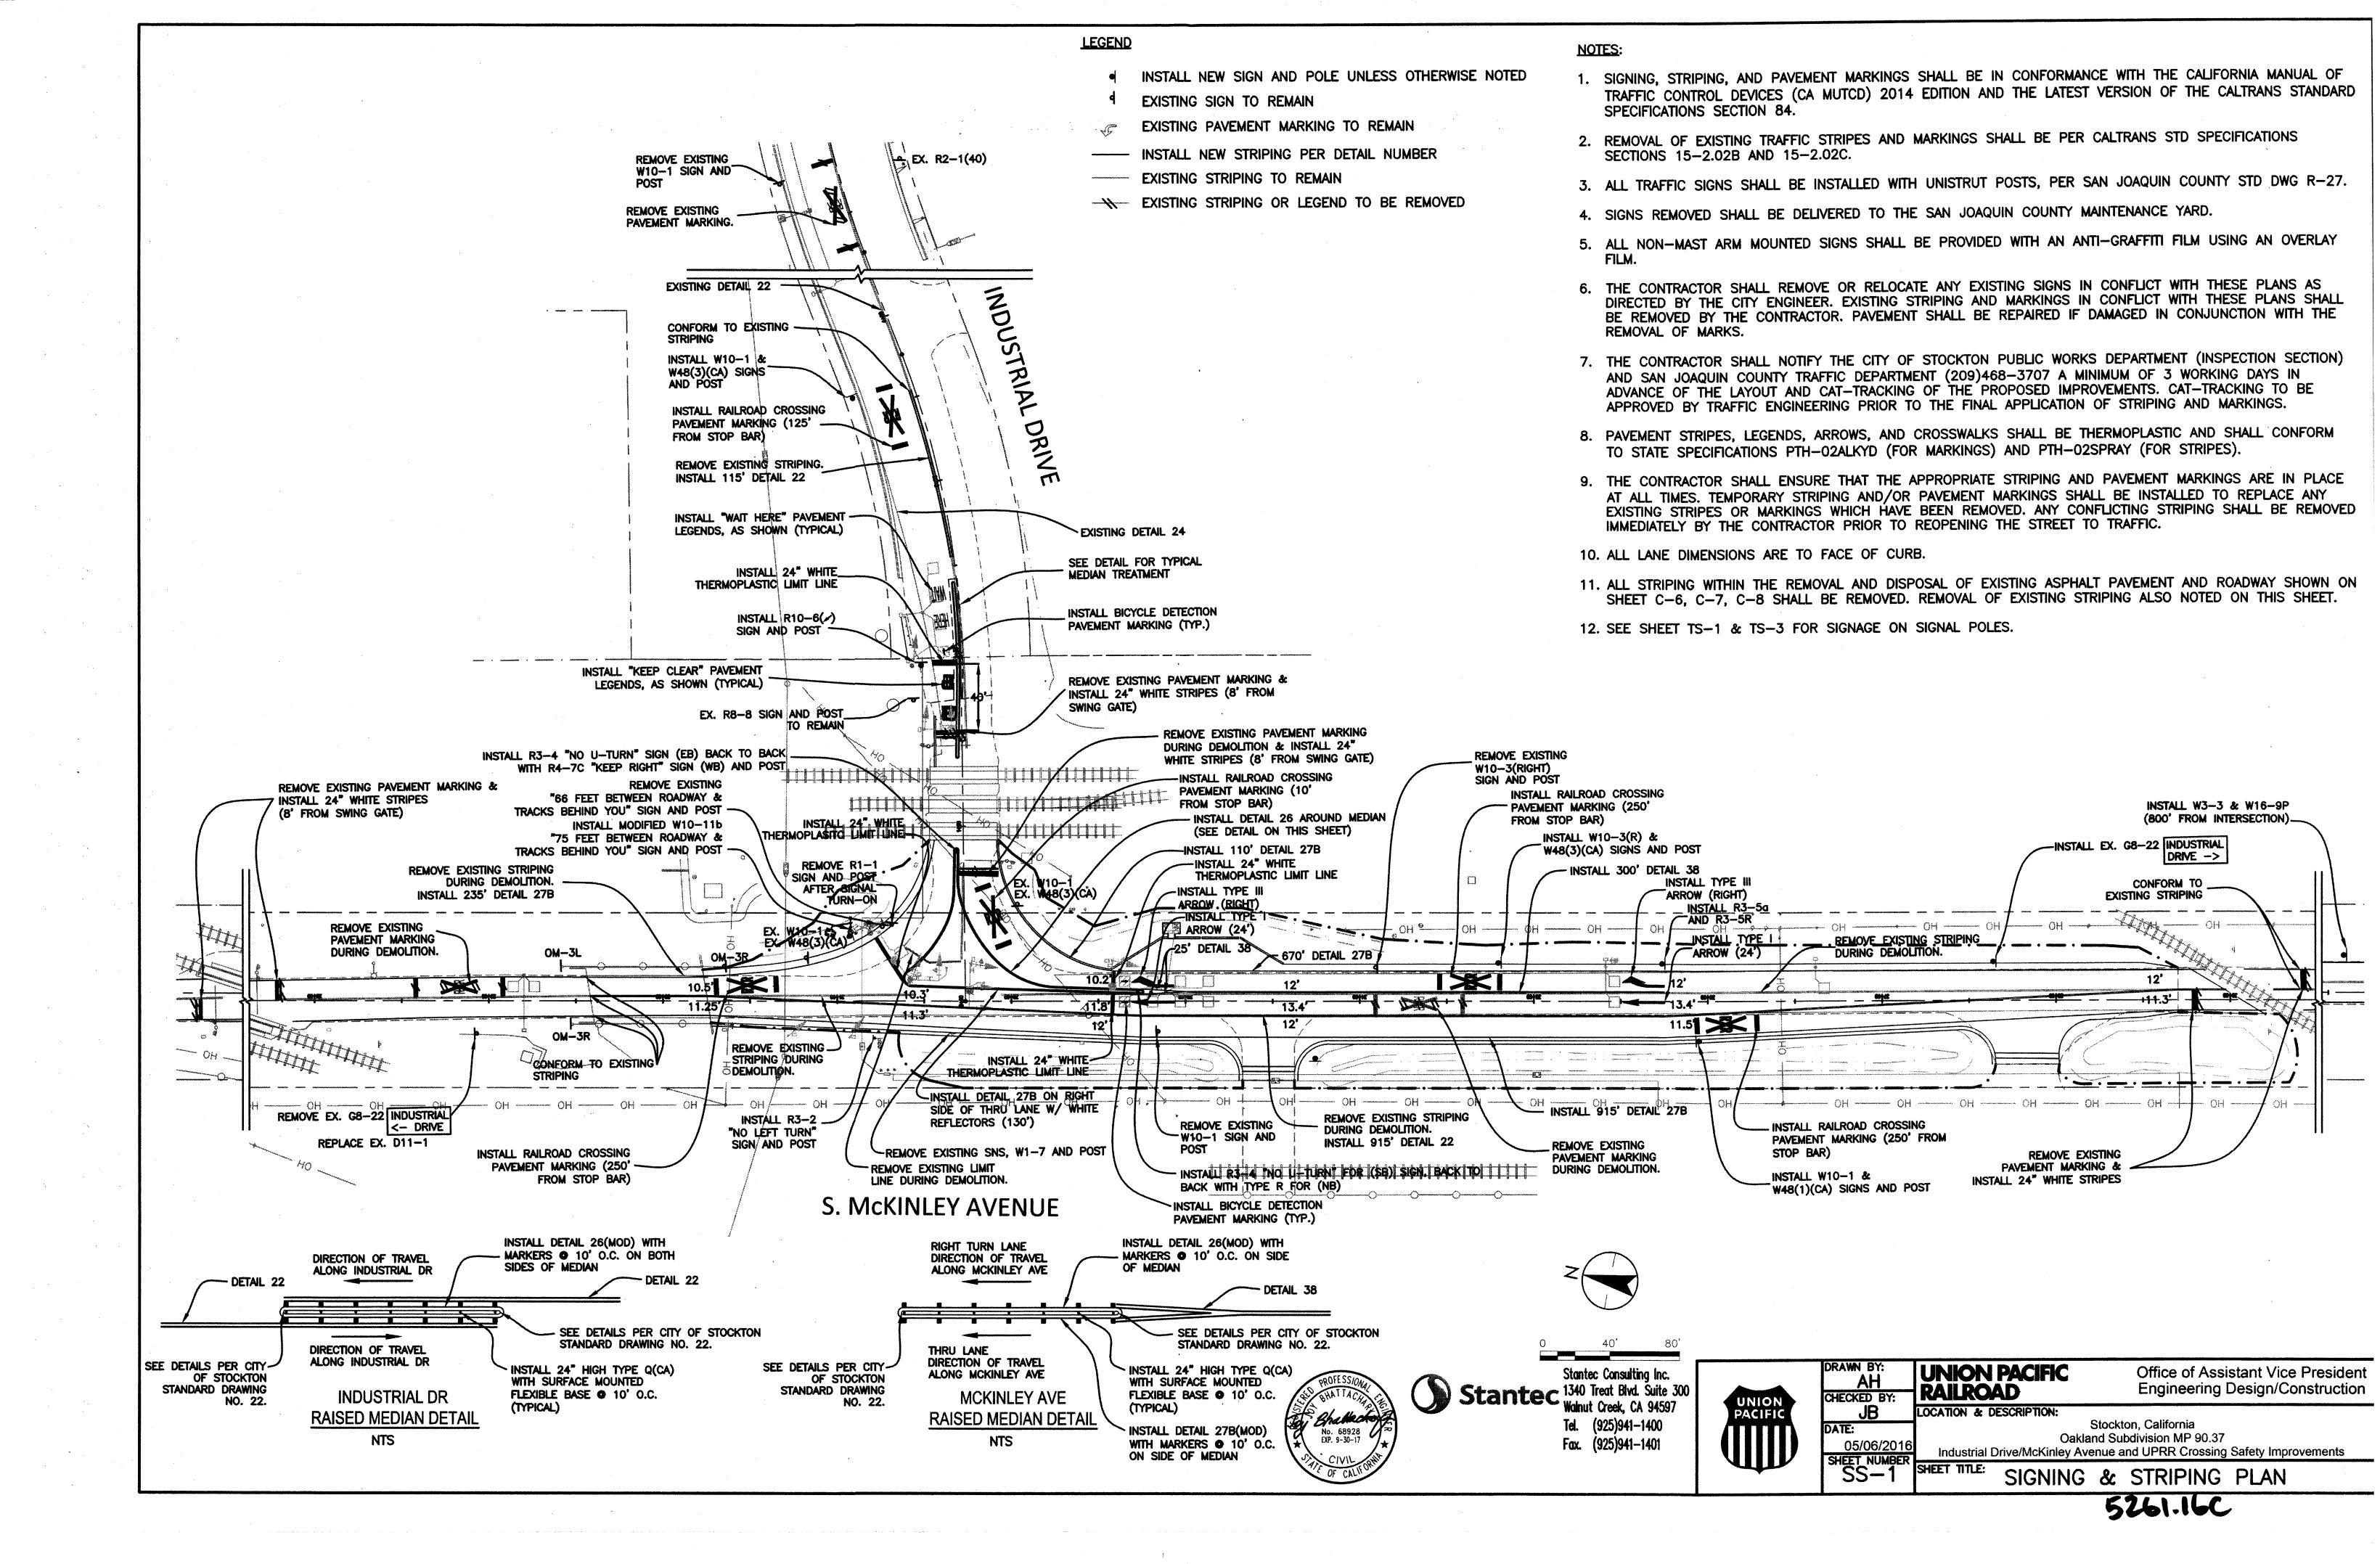



SIGN	DESCRIPTION	DIMENSION		
R3-2	NO LEFT TURN	24x24		
R3-4	NO U TURN	24x24		
R3-5	RIGHT TURN ONLY	30x36		
R4-7C	KEEP RIGHT	18x30		
R5-1A	WRONG WAY	30x30		
R10-6(/)	STOP HERE ON RED	24x36		
R13A (CA)	NO RIGHT TURN ON RED	18x30		
SNS	STREET NAME SIGN	VARY		
W10-1	GRADE CROSSING ADVANCE WARNING	DIA. 30		
W10-3(R)	GRADE CROSSING ADVANCE WARNING	30x30		
W48(1)(CA)	THE NUMBER OF TRACK	30x24		
W48(3)(CA)	THE NUMBER OF TRACK	30x24		









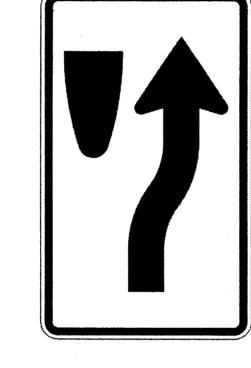


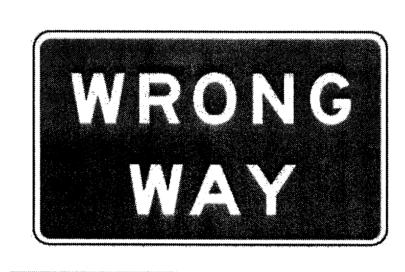



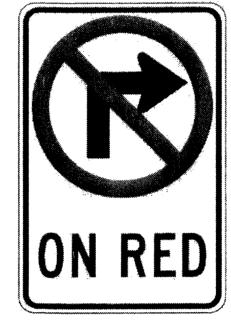

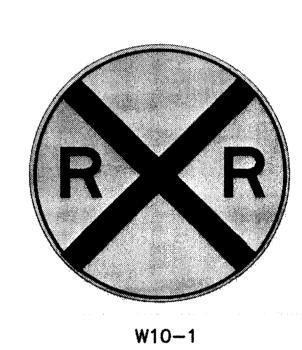

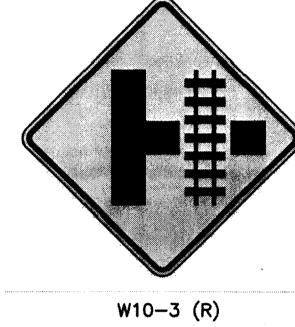

R3-2

R3-4

R3-5

R4-7C

R5-1A

R10-6

R13A (CA)



W48(1)(CA)

W48(3)(CA)





Stantec Consulting Inc.

1340 Treat Blvd. Suite 300
Walnut Creek, CA 94597
Tel. (925)941–1400
Fax. (925)941–1401




DRAWN BY:	
AH	}
CHECKED BY:	
JB	LC
DATE:	
05/06/0046	ŀ

UNION PACIFIC RAILROAD LOCATION & DESCRIPTION:

Office of Assistant Vice President Engineering Design/Construction

Stockton, California
Oakland Subdivision MP 90.37
Industrial Drive/McKinley Avenue and UPRR Crossing Safety Improvements O5/06/2016 Industrial Drive/McKinley Avenue and UPRR Crossing Safety Improver SS-2 SIGNING & STRIPING LEGEND

5261.170

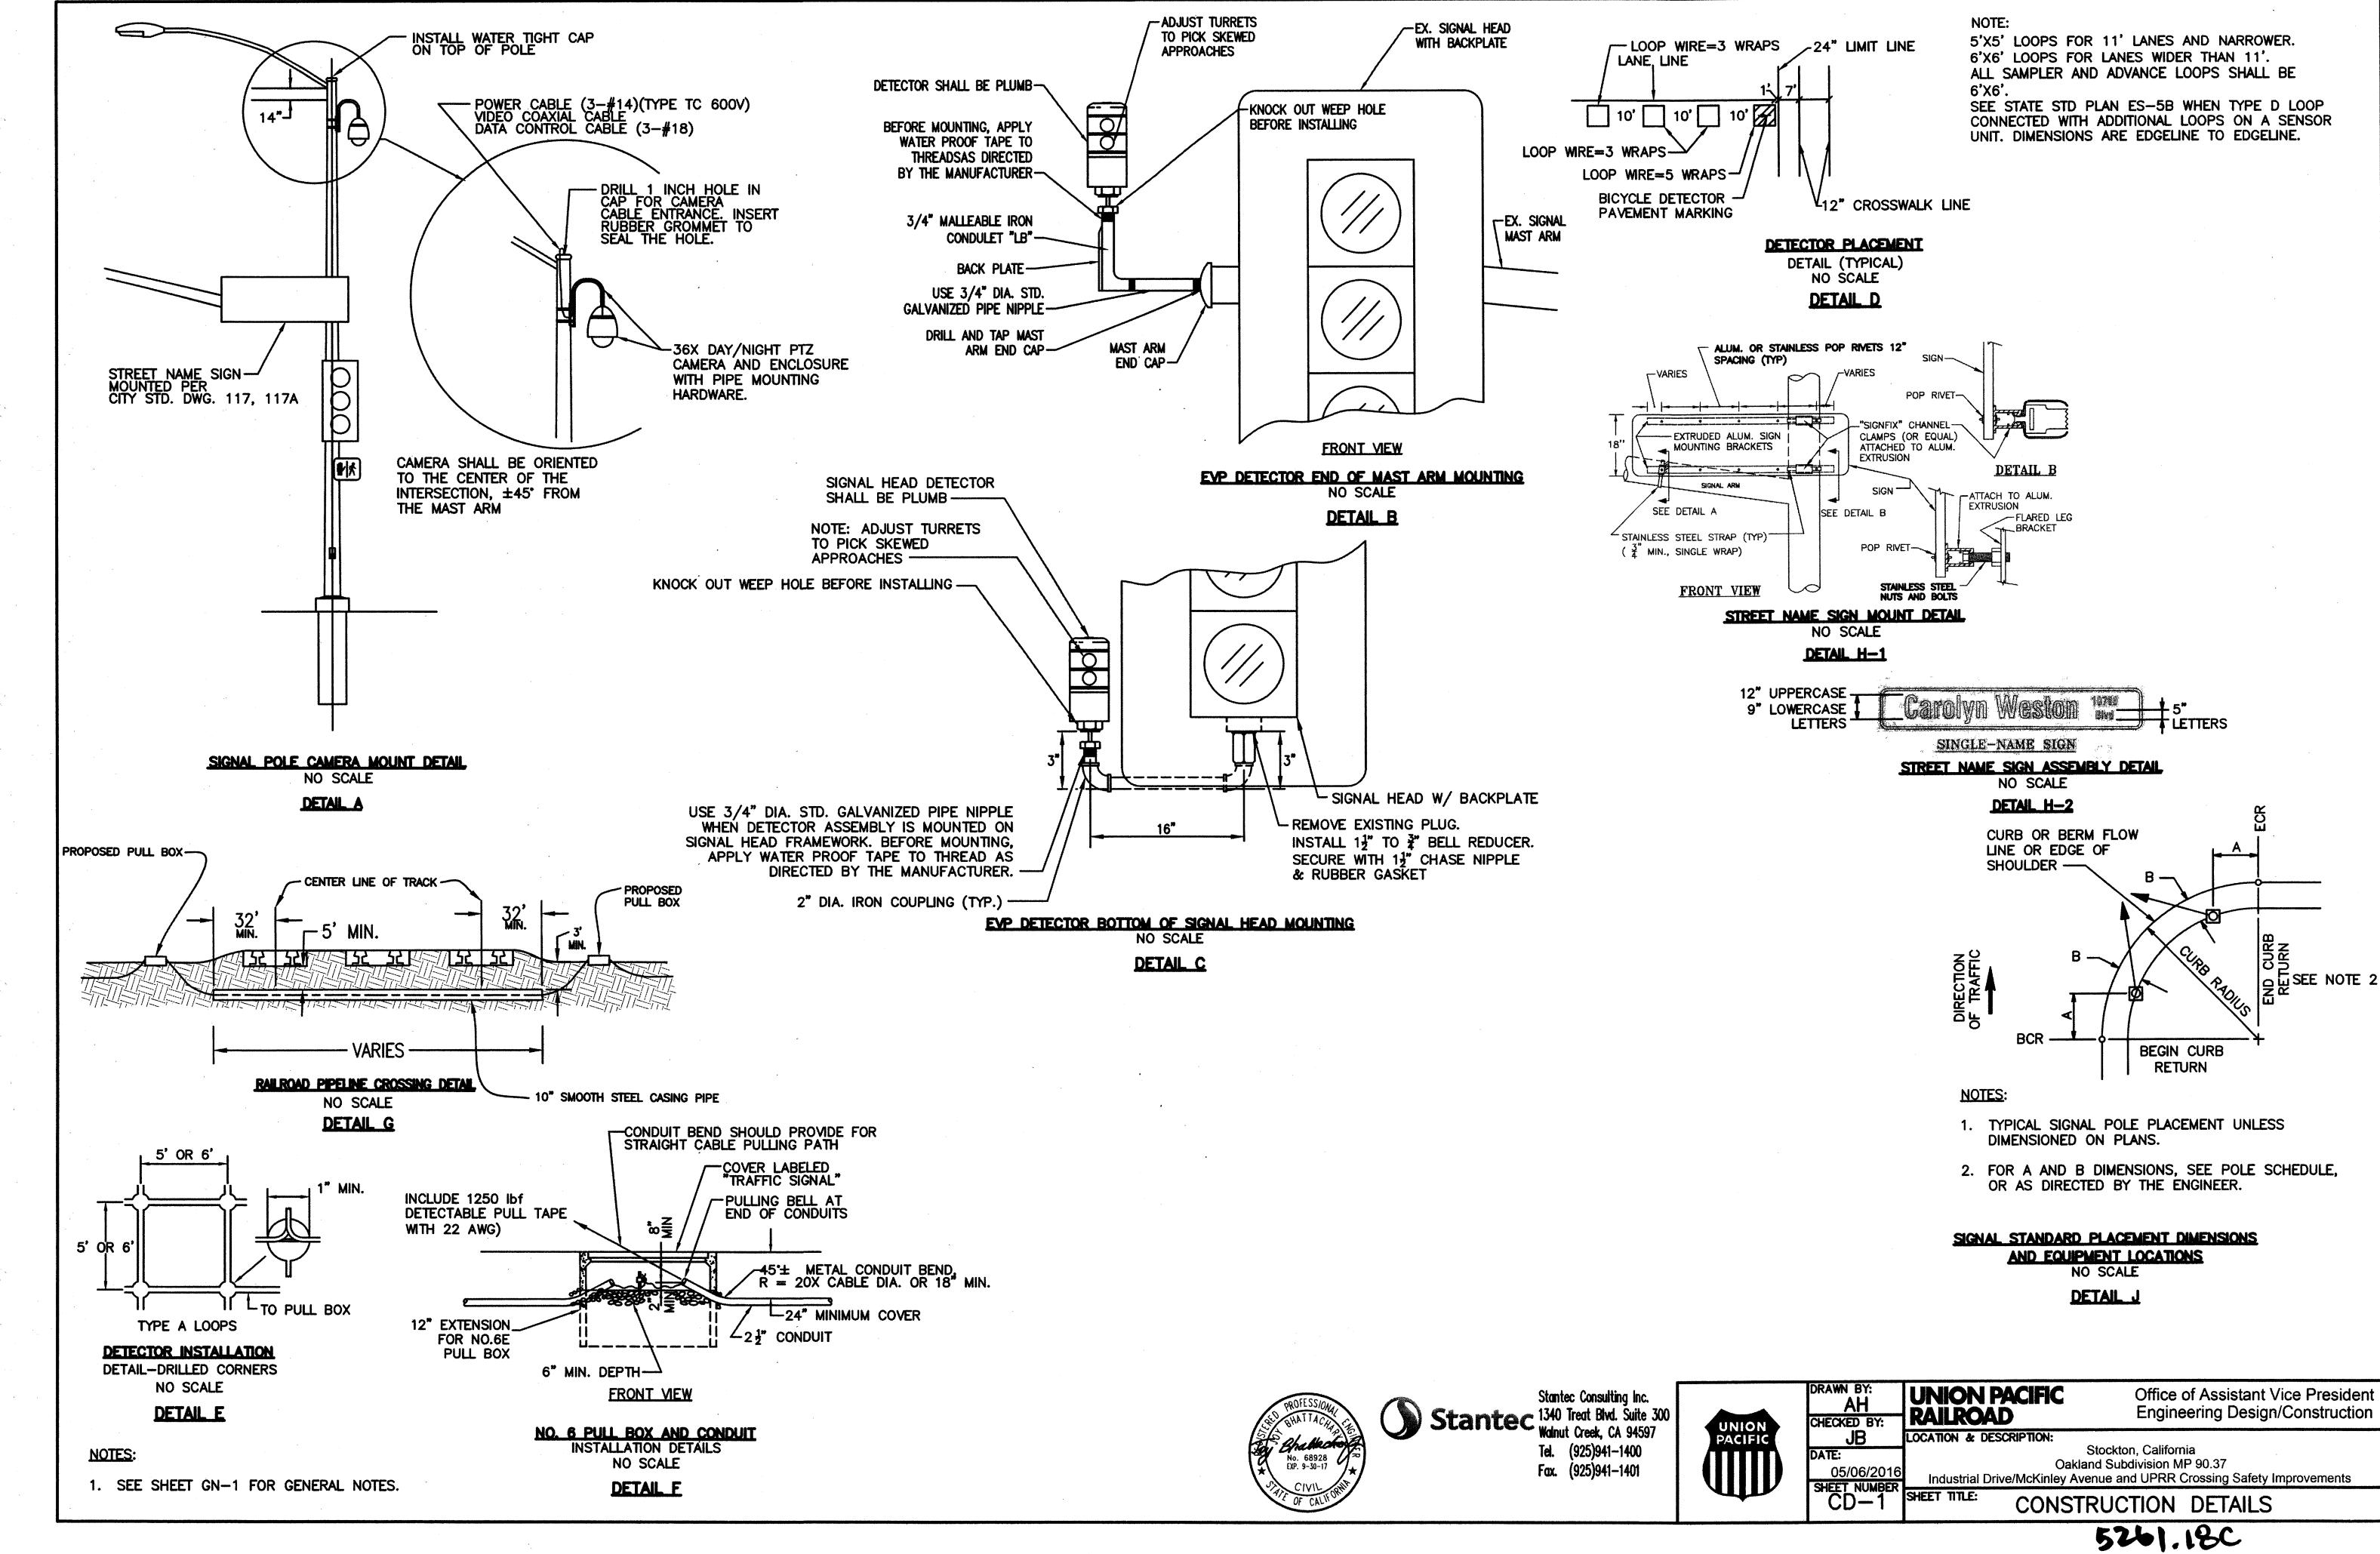

LOCATION MAP




7920 CUCAMONGA AVE SACRAMENTO CA 95826 jmurphy@stssi.com 916-452-4855

Statewide Traffic Safety and Signs("Statewide") shall not be responsible for, and [SIEGFRIED & STOCKTON] shall indemnify, defend and hold harmless Statewide and its agents, representatives and employees from and against, any claims, costs, damages, liabilities, expenses, demands and losses (including attorney's fees and costs and expenses) arising out of or relating to the failure of any Traffic Control Plan applicable to Statewide's work or services to comply with any local, state or federal rule, regulation, ordinance, or statute. [SIEGFRIED & STOCKTON] agrees that the Statewide is entitled to and will rely on the written Traffic Control Plan(s) provided to Statewide by [SIEGFRIED & STOCKTON] and its agents, representatives and employees in the performance of Statewide's work or services.

POSTED SPEED	FORMULA	MULA BUFFER SPACE				MINIMUM TAPER LENGTHS						MAXIMUM SIGN LID		LIDG					MCKINLEY AVE			
			10' OFFSET			11' OFFSET			12' OFFSET			SPACING		SPACING (
			L 1/2 L	1/3 L	<u>L</u>	1/2 L	L 1/3 L	L	1/2 L	1/3 L	T	TAPER	. / \	Δ								
							MERGE	SHIFT	SHOULDER	MERGE	SHIFT	SHOULDER	MERGE	SHIFT	SHOULDER	LONG	& LIDG	<u> </u>			2014	
25		155'	104'	52'	35'	115'	57'	38'	125'	63'	42'	25'	13'	100'	94'	RECOMMENDED ADVANCED V (CA MUTCD 2012 ED			NG TABLE			
30	L= <u>WS2</u>	L= <u>WS2</u>	200'	150'	75'	50'	165'	83'	55'	180'	90'	60'	30'	15'	250'	113'	SEE TABLE FOR ADDIT				SPEED	
35	60	250'	204'	102'	68'	225'	112'	75'	245'	123'	82'	35'	18'	250'	131'							
40		305'	267'	133'	89'	293'	147'	98'	320'	160'	107'	40'	20,	350'	150'	ROAD TYPE	A	В	С	55		
45	·	360'	450'	225'	150'	495'	248'	165'	540'	270'	180'	45'	23'	350'	169'							
50		425'	500'	250'	167'	550'	275'	183'	600'	300'	200'	50'		400' TO 600'		URBAN (LOW SPEED)	100'	100'	100'			
55	L=WS	495'	550'	275'	183'	605'	303'	202'	660'	330'	220'	50'		440' TO 660'	210	25 MPH OR LESS				COMPASS		
60		570'	600'	300'	200'	660'	330'	220'	720'	360'	240'	50'	<u> </u>			URBAN (LOW SPEED) MORE THAN 25 MPH	250'	250'	250'			
65 70		645'	650'	325'	217'	715'	358'	238'	780'	390'	260'	50'		520' TO 700'	244	TO 40 MPH				N ↑		
7,0		730'	700'	350'	233'	770'	385'	257'	840'	420'	280'	50'	30	560 10 620	203	URBAN (HIGH SPEED) MORE THAN 40 MPH	350'	350'	350'			
	EED IS 40 MI																			₩		
	EED IS 45 MI RE BASED O		ic.													RURAL	500'	500'	500'			

GENERAL NOTES

- 1. THIS PLAN SUPPLEMENTED WITH 2014 CA MUTCD.
- 2. THE LOCATION OF THE SIGNS SHOWN ON THE PLAN ARE GUIDELINES AND ACTUAL LOCATIONS WILL DEPEND UPON ALIGNMENT, GRADE, LOCATION OF THE STREET INTERSECTIONS, AND THE 85TH PERCENTILE.
- 3. ONLY ONE SIDEWALK WILL BE CLOSED AT A TIME. PEDESTRIAN AND DISABLED ACCESS TO BE MAINTAINED PER 2014 CA MUTCD STANDARD (STOCKTON USE STANDARD CONSTRUCTION SPEC)
- 4. NOTHING ALLOWED IN BUFFER/TRANISTION AREA AT ANY TIME.
- 5. NOTIFY LOCAL LAW ENFORCEMENT, FIRE, AMBULANCE COMPANIES WITHIN 24 HOURS BEFORE CONSTRUCTION BEGINS. KEEP OPEN ACCESS FOR EMERGENCY VEHICLES AT ALL TIMES.
- 6. SIGNS AND CHANNELIZING DEVICES MUST BE RETRO REFLECTIVE OR ILLUMINATE DURING THE NIGHT. MINIMUM VIABILITY 1000
- 7. CONTINUOS MONITORING AND MAINTEAINCE OF THE TRAFFIC CONTROL ZONE WILL BE IMPLEMENTED FOR THE PURPOSE OF MAINTAINING EMERGENCY ACCESS, ACCOMMODATION FOR PEDESTRIANS, BICYCLE TRAFFIC AND THE DISABLED.
- 8. ALL CONFLICTING MARKINGS ARE TO BE REMOVED FOR PROJECTS THAT LAST A TERM OF 3 DAYS OR LONGER.
- 9. ALL SIGNS IMPLEMENTED WILL ONLY BE VIEWABLE WHEN IN USE, OTHERWISE ALL WARNING DEVICES WILL BE TAKEN DOWN OR COVERED.
- 10. PROPER TRAINING OF TRAFFIC CONTROLLERS, PROPER DEVICES & PROPER USE OF THE DEVICES ARE REQUIRED AT ALL TIMES.

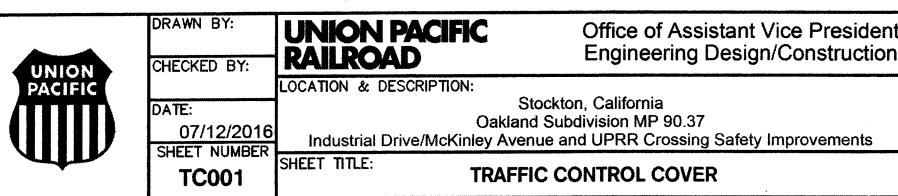

LONG AS POSSIBLE. SEE SHEET VO01

AND ROO1 FOR DETAILS.

12' OFFSET = 660'

Stockton, California
Oakland Subdivision MP 90.37
Industrial Drive/McKinley Avenue and UPRR Crossing Safety Improvements

TRAFFIC CONTROL PLAN I

07/12/2016

TC002

